


## 1 STAGE FLOOR PLAN

SCALE1:100m.

OUNTE CITY ENGLAND	Republika ng Pilipinas Lungsod ng Quezon CITY ENGINEERING DEPARTMENT
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	PROJECT TITLE:	DRAWN BY : mnm/brgz	SUBMITY€D BY:		RECOMMENDING APPROVAL:	APPROVED BY :	SHEET CONTENT	SHEET NO.
NT	PROPOSED CONSTRUCTION OF STAGE AT RAMON MAGSAYSAY HIGH SCHOOL	DATE : OCT. 07, 2020 CHECKED BY:	ENGR. VEO S. DEL ROSARIO			UON MA JOSEPHA O PELADATE	STAGE FLOOR PLAN	AR-02
	BARANGAY PALIGSAHAN, DISTRICT 4, QUEZON CITY	REVISION NO.:		PLANNING & PROGRAMMING DIVISION	OTC, CITY ENGINEERING DEPARTMENT	HON, MA, JOSEFINA G, BELMONTE CITY MAYOR, QUEZON CITY		

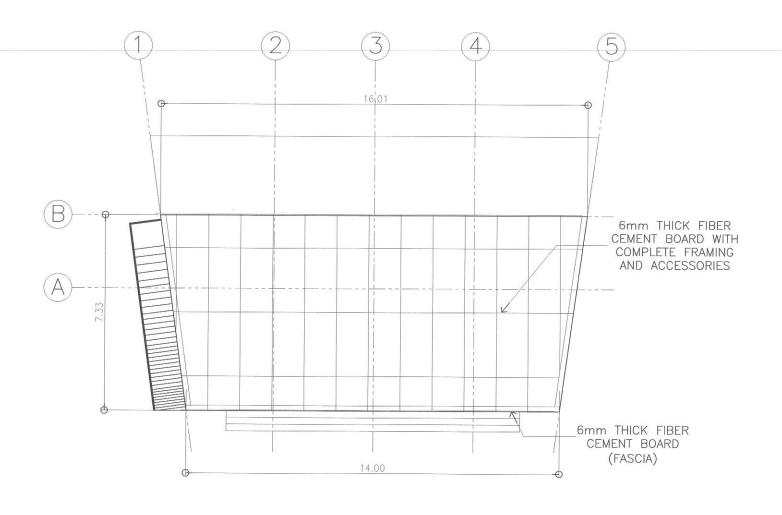

# 1 ROOFING PLAN PROJECT TITLE: DRAWN BY: mnnv/brgz SUBMITTED BY: Republika ng Pilipinas

Republika ng Pilipinas Lungsod ng Quezon  CITY ENGINEERING DEPARTMEN
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ROPOSED CONSTRUCTION OF STAGE T RAMON MAGSAYSAY HIGH SCHOOL BARANGAY PALIGSAHAN, DISTRICT 4, QUEZON CITY	DATE : OCT. 07, 2020		1
	CHECKED BY: 🖊	ENCP I	ED S. DEL ROSARIO
BARANGAY PALIGSAHAN, DISTRICT 4, QUEZON CITY	REVISION NO.:		NING & PROGRAMMING DIVISION


$\wedge$	
ENGR. ISASANI R. VERZOSA, JR. OIC, CITY ENGINEERING DEPARTMENT	

HON. MA. JOSEFINA G. BELMONTE	STAGE ROOFING PLAN	AR-03

SHEET CONTENT

SCALE1:100m.

SHEET NO.

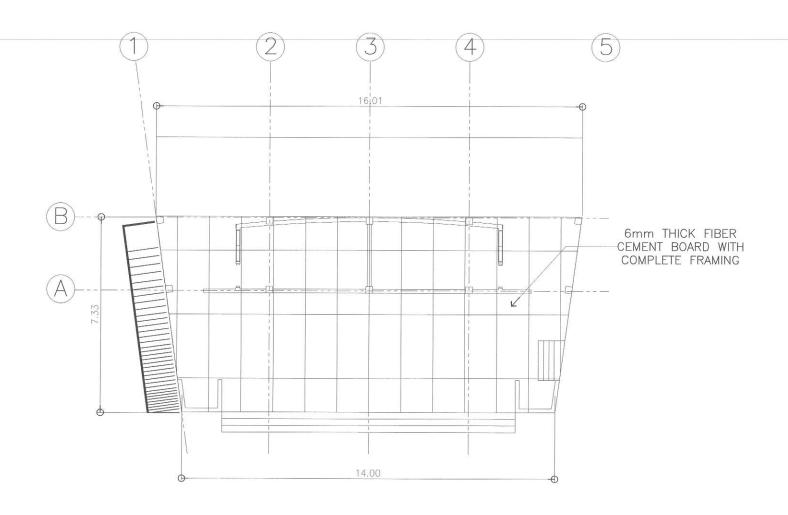

# 1 CEILING PLAN (STAGE)

SCALE1:100m.

OF THE CITY ENC.	
NA N	CI
OUEZON CITY	

Republika ng Pilipinas Lungsod ng Quezon CITY ENGINEERING DEPARTMENT

PROJECT TITLE :			
PROPOSED CONSTRUCTION OF STAGE			
AT RAMON MAGSAYSAY HIGH SCHOOL	CHE		
BARANGAY PALIGSAHAN, DISTRICT 4, QUEZON CITY	REV		

: OCT. 07, 2020	$( \setminus \land \land )$
KED BY:	ENGR. LEO S. DEL ROSARIO
SION NO.:	HEAD, PLANNING & PROGRAMMING DIVISION

SUBMITTED BY:


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ENGD IS	ASINI R. VERZOSA, JR
	CITY ENGINEERING DEPARTMENT


APPROVED BY :

RECOMMENDING APPROVAL:


HON. MA. JOSEFINA G. BELMONTE CITY MAYOR, QUEZON CITY	REFLECTED CEILING PLAN	AR-04

SHEET CONTENT

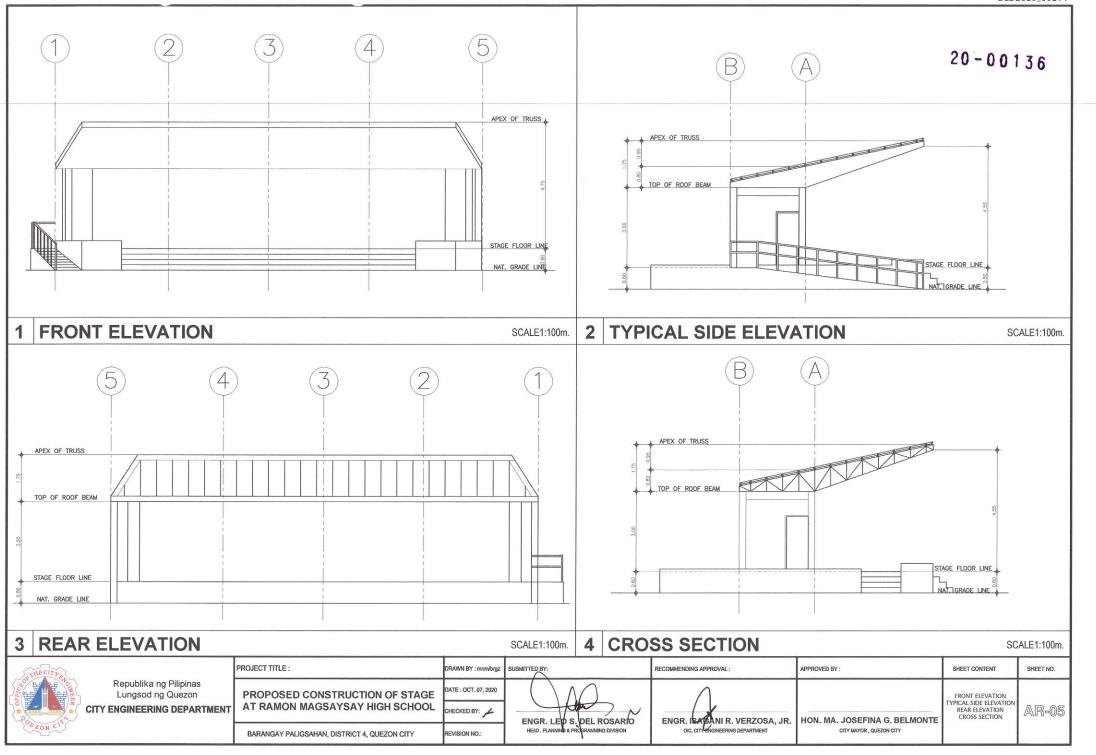


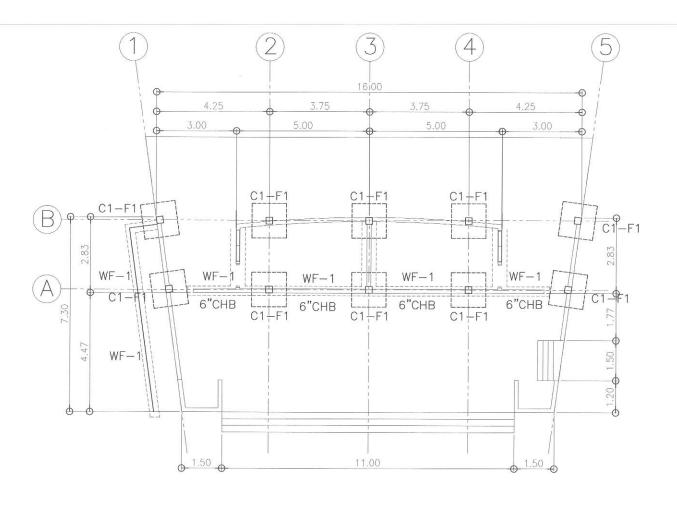

Ŀ	1 FOUND	ATION PLAN (S	STAGE)					SC	CALE1:100m.
	&THE CITY	1	PROJECT TITLE:	DRAWN BY : mnm/brgz	SUBMITTED BY:	RECOMMENDING APPROVAL:	APPROVED BY :	SHEET CONTENT	SHEET NO.
5		Republika ng Pilipinas Lungsod ng Quezon	PROPOSED CONSTRUCTION OF STAGE	DATE: OCT. 07, 2020	(	Λ.			
3	CITY	ENGINEERING DEPARTMENT	AT RAMON MAGSAYSAY HIGH SCHOOL	CHECKED BY:	ENGR. LED S. DEL ROSARIO	ENGR. SACANIR VERZOSA JR.	HON, MA, JOSEFINA G, BELMONTE	FOUNDATION PLAN	ST-01
	ason C.	BARAN	BARANGAY PALIGSAHAN, DISTRICT 4, QUEZON CITY	REVISION NO.:	HEAD , PLANNING & PROGRAMMING DIVISION	OIC, CITY ENGINEERING DEPARTMENT	CITY MAYOR , QUEZON CITY		

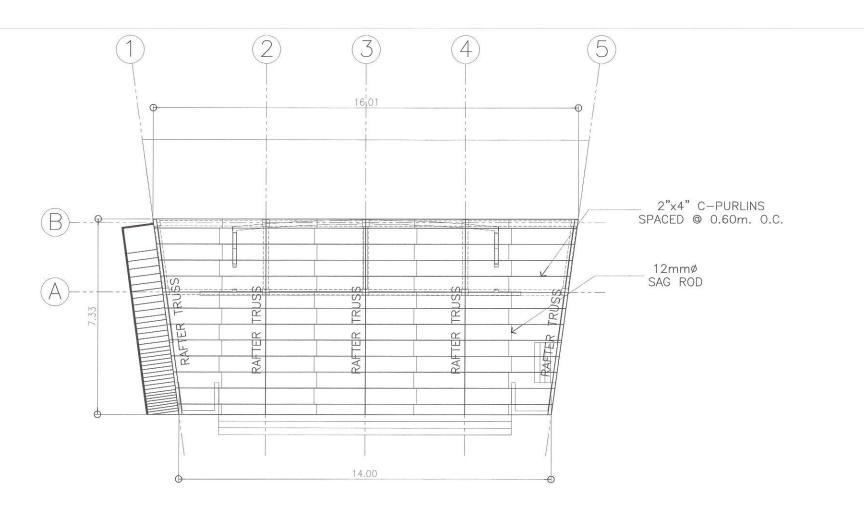


#### ROOF FRAMING PLAN (STAGE) SCALE1:100m. PROJECT TITLE : DRAWN BY : mnm/brgz RECOMMENDING APPROVAL: APPROVED BY : SHEET CONTENT SHEET NO. Republika ng Pilipinas DATE: OCT. 07, 2020 Lungsod ng Quezon PROPOSED CONSTRUCTION OF STAGE CITY ENGINEERING DEPARTMENT AT RAMON MAGSAYSAY HIGH SCHOOL CHECKED BY: ROOF FRAMING PLAN ST-02 ENGR. LEO S. DEL ROSARIO HEAD, PLANNING & PROGRAMMING DIVISION ENGR. ISAGANI R. VERZOSA, JR. OIC, CITY ENGINEERING DEPARTMENT HON. MA. JOSEFINA G. BELMONTE BARANGAY PALIGSAHAN, DISTRICT 4, QUEZON CITY

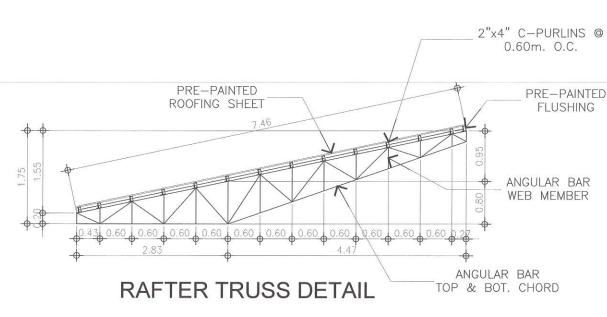


#### BEAM SCHEDULE

MARK	DIME	DIMENSION		RIGHT SUPPORT		MID-SPAN		UPPORT	WEB BAR	STIRRUPS
	B(mm)	H(mm)	TOP	воттом	TOP	воттом	TOP	воттом		10mmØ DSB
RB - 1	200	300	3 - 16Ø	2 - 16Ø	2 - 16Ø	3 - 16Ø	3 - 16Ø	2 - 16Ø		1 @ 0.05, 3 @ 0.10, 3 @ 0.15 & REST @ 0.25 M.O.C.

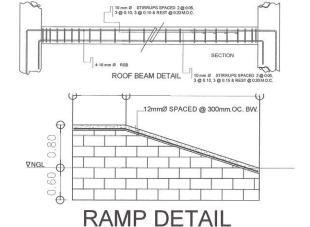



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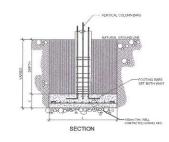

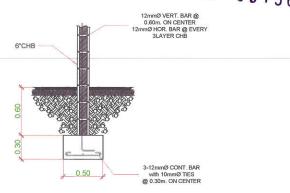
## WALL FOOTING DETAIL (WF-1)

#### **COLUMN SCHEDULE**



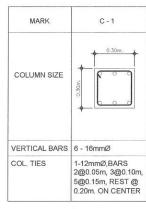

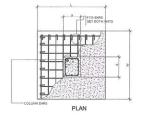

#### FOOTING SCHEDULE

RECOMMENDING APPROVAL:

MARK	DIMENS	IENSION t (mm)		SS	LS	EMBEDMENT (mm)	
	W (mm)	L (mm)					
F - 1	1300	1300	300	7 - 16mm Ø	7 - 16mm Ø	2.00m MINIMUM	

APPROVED BY



Republika ng Pilipinas Lungsod ng Quezon CITY ENGINEERING DEPARTMENT

PROJECT TITLE :

PROPOSED CONSTRUCTION OF STAGE AT RAMON MAGSAYSAY HIGH SCHOOL

BARANGAY PALIGSAHAN, DISTRICT 4, QUEZON CITY

DATE : OCT. 07, 2020

CHECKED BY: 

REVISION NO.:

RAWN BY: mnm/brgz

SUBMITTED BY

ENGR. EO S. DEL ROSARIO HEAD, PLANKING & PROGRAMMING DIVISION

ENGR. BAÇANI R. VERZOSA, JR.

HON, MA, JOSEFINA G, BELMONTE

RAFTER TRUSS DIAGRAM COLUMN & FOOTING DET. BEAM SCHED. & DETAIL WALL FOOTING DET. RAMP DETAIL

SHEET CONTENT

ST-03

SHEET NO.

- 1. ALL ELECTRICAL WORKS SHALL BE DONE IN ACCORDANCE WITH THE PROVISIONS OF THE LATEST EDITION OF THE PHILIPPINE ELECTRICAL CODE, THE LAWS AND ORDINANCES OF THE LOCAL CODE ENFORCING AUTHORITIES AND THE REQUIREMENTS OF THE LOCAL POWER AND TELEPHONE UTILITY COMPANY
- 2. THE CONTRACTOR SHALL SECURE ALL PERMITS AND PAY ALL FEES REQUIRED FOR THE WORK AND SHALL FURNISH THE OWNER THROUGH THE ENGINEERS, FINAL CERTIFICATES OF ELECTRICAL INSPECTION AND APPROVAL FROM PROPER GOVERNMENT AUTHORITIES FOR COMPLETION OF WORK.
- 3. ALL EMBEDDED BRANCH CIRCUITS SHALL BE PVC CONDUITS AND FOR EXPOSED INSTALLATION SHALL BE IMC SUPPORTED BY CONDUIT CLAMPS EVERY 700 MILIMETERS
- 4. PULL BOXES SHALL BE PROVIDED BY THE CONTRACTOR WHENEVER NECESSARY TO FACILITATE WIRE PULLING EVEN IF THESE ARE NOT INDICATED ON THE PLANS. SIZING OF ALL PULLBOXES SHALL BE COMPUTED BASED ON THE CODE REQUIREMENTS, SUBMIT SHOP DRAWINGS TO THE ENGINEER FOR APPROVAL PRIOR TO FABRICATION. LOCATION OF PULLBOXES SHALL BE APPROVED BY THE ARCHITECT/ENGINEER AND MUST BE REFLECTED ON THE "AS-BUILT" PLAN.
- 5. ALL POWER OUTLETS AND SWITCHES SHALL BE GROUNDING TYPE WITH PARALLEL SLOTS FOR 230 V.
- PROVIDE GROUND FAULT CURRENT INTERRUPTER CIRCUIT BREAKER FOR LOADS MARKED "GFCI" ON THE PLAN.
- ALL METALLIC CONDUITS, CABINETS AND EQUIPMENT SHALL BE PROPERLY GROUNDED AND BONDED.
- 8. UNLESS OTHERWISE NOTED, MOUNTING HEIGHT FOR WALL MOUNTED DEVICES SHALL BE AS FOLLOWS:

RECEPTACLE OUTLET - 300 MM AFF, 150MM ABOVE WORKING COUNTER

TELEPHONE OUTLET - 300 MM AFF CATV OUTLET - 300 MM AFF

LIGHTING SWITCH - 1400 MM AFF PANELBOARD - 1600 MM AFF

- 9. REFER TO MECHANICAL, PLUMBING ANF FIRE PROTECTION DRAWINGS FOR RATINGS AND LOCATIONS OF EQUIPMENT AS WELL AS THEIR CONTROL SEQUENCES AS SPECIFIED AND OR SHOWN UNDER THEIR RESPECTIVE SECTIONS.
- 10. ALL MATERIALS TO BE USED SHALL BE OF THE BEST QUALITY. BRAND NEW AS SPECIFIED
- 11. THE DRAWINGS AND SPECIFICATIONS ARE INTENDED TO PRESENT GENERAL LAYOUT AND BROAD OUTLINE/DESCRIPTION OF THE PROJECT BUT DO NOT NECESSARILY INDICATE/DESCRIBED ACTUAL LOCATIONS, LEVEL AND DISTANCES OF THE EQUIPMENT. THE CONTRACTOR IS HEREBY REQUIRED TO MAKE SUCH ADJUSTMENT AT THE JOBSITE AS LOCATION, DISTANCES AND LEVELS ARE GOVERNED BY ACTUAL FIELD CONDITIONS.
- 12. ANY DISCREPANCY BETWEEN THE PLANS AND SPECIFICATIONS SHALL BE BROUGHT TO THE ATTENTION OF THE ENGINEER FOR CLARIFICATION DECISION.
- 13. ALL LIGHTING AND CONVENIENCE OUTLET CIRCUITS SHALL BE 3.5 SQ. MM. THWN-2 COPPER WIRE UNLESS OTHERWISE NOTED. MINIMUM SIZE OF WIRE SHALL BE 3.5 SQ, MM, COPPER WIRE, ALL WIRES AND CABLES SHALL BE COLOR CODED AS FOLLOWS:

LINE 1 - RED

LINE 2 - YELLOW

NEUTRAL - WHITE

GROUND - GREEN

14. BOXES, WIRE, GUTTERS, ENCLOSURE SHALL BE FABRICATED FROM STEEL WITH THICKNESS AS FOLLOWS:

MAXIMUM WIDTH OF THE WIDEST SURFACE STEEL

UP TO INCLUDING 152.40 MM

GA 16 PAINTED WITH METAL PRIMER EPOXY AND TOPCOAT


OVER 152,40 MM BUT NOT OVER 457.30

GA 14 PAINTED WITH METAL PRIMER EPOXY AND TOPCOAT

OVER 457.30 MM BUT NOT OVER 762 MM

GA 12 PAINTED WITH METAL PRIMER EPOXY AND TOPCOAT GA 10 PAINTED WITH METAL PRIMER EPOXY AND TOPCOAT

- 15. ALL ELECTRICAL WORKS HEREIN SHALL BE EXECUTED BY EXPERIENCED MEN UNDER THE DIRECT SUPERVISION OF A FULL-TIME LICENSED ELECTRICAL ENGINEER AND A DULY ACCREDITED ELECTRICAL CONTRACTOR BY PCAB. WORKS SHALL BE NEATLY PLACED, SECURELY FASTENED AND PROPERLY
- 16. TYPE OF SERVICE ENTRANCE SHALL BE SINGLE-PHASE, TWO-WIRE PLUS GROUND, 60 HERTZ, 230V AC NOMINAL.
- 17. CONDUITS IN NO CASE SHALL THERE BE MORE THAN THE FOLIVALENT OF FOUR QUARTER BENDS IN ANY ONE RUN ALL CONDUIT BENDS SHALL BE FIELD MADE BY USING HYDRAULIC BENDERS, MINIMUM BENDING RADIUS MUST BE IN ACCORDANCE TO THE CODE REQUIREMENTS.
- 18. UPON COMPLETION OF ELECTRICAL CONSTRUCTION WORK, INSULATION RESISTANCE TEST AND FUNCTIONALITY TEST SHALL BE PERFORMED BY THE CONTRACTOR INCLUSIVE OF THE INSTALLATION TO BE REPORTED IN DETAILS ON FORMS APPROVED BY THE QUEZON CITY ENGINEERING DEPARTMENT REPRESENTATIVE. THE GROUND RESISTANCE FOR ELECTRICAL SYSTEMS SHALL NOT BE MORE THAN 5 OHMS, COMMUNICATION GROUNDING RESISTANCE SHALL NOT EXCEED 2 OHMS.

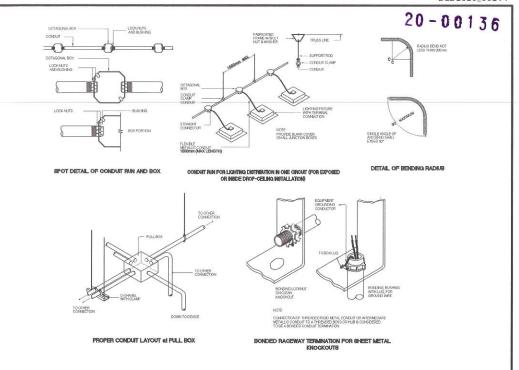

## 2 MISCELLANEOUS DETAILS

SCALE: NTS

CIRCUIT LINE SWITCH LINE

10W LED PINLIGHT

SINGLE GANG SWITCH TWO GANG SWITCH

S3 THREE GANG SWITCH

CONVENIENCE DUPLEX OUTLET



SPECIAL PURPOSE OUTLET (ACU)



3 LEGEND & SYMBOLS

CIRCUIT HOMERUN



MAIN DISTRIBUTION PANEL

APPROVED BY :

## **GENERAL NOTES**

CITY ENGINEERING DEPARTMENT

Republika ng Pilipinas Lungsod ng Quezon

PROJECT TITLE: DATE: OCT. 07, 2020 PROPOSED CONSTRUCTION OF STAGE AT RAMON MAGSAYSAY HIGH SCHOOL CHECKED BY:

BARANGAY PALIGSAHAN, DISTRICT 4, QUEZON CITY

ENGR. LEO S DEL ROSARIO

ENGR. ISA GANI'R. VERZOSA, JR.

RECOMMENDING APPROVAL

HON. MA. JOSEFINA G. BELMONTE CITY MAYOR . QUEZON CITY

SCALE: NTS SHEET NO.

SHEET CONTENT

**GENERAL NOTES** 

EL-01

SCALE: NTS RAWN BY : mnm/brgz SUBMITTED BY

REVISION NO.:

### **LIGHTING & POWER PANEL: "LPP"**

MAIN CIRCUIT BREAKER INTERRUPTING CAPACITY @ 240 VOLTS 10 KAIC BRANCHES CIRCUIT BREAKER INTERRUPTING CAPACITY @ 240 VOLTS 10 KAIC LOCATION: GROUND FLOOR

240 VOLTS, SINGLE PHASE, 2 - WIRE AND GROUND FLUSHED MOUNTED, NEMA 1, WITH GROUNDING TERMINAL STRIP

CENTER MAIN: 40AT 2P. TMCB BOLT - ON

CKT	VOLTS	OUTLET		OTHER LOAD SERVICE	AMPE	AMPERE LOAD		VOLT	CIRCUIT	CIZE OF WIDE AND CONDUITO
NO.	VULIS	LO	CO	OTHER LOAD SERVICE		1Ø	3 Ø	AMPERE	BREAKER	SIZE OF WIRE AND CONDUITS
1	230	26				5.65		1,300	20 AT 2P, BOLT ON	2 - 3.5mm² THHN WIRE IN 20mm Ø (½") PVC
2	230		5			3.91		900	20 AT 2P, BOLT ON	2 - 3.5mm² THHN WIRE and 1(ONE) 3.5mm2 THHN GROUND WIRE IN 20mm Ø ( $\frac{1}{2}$ ) PVC
3	230		5			3.91		900	20 AT 2P, BOLT ON	2 - 3.5mm² THHN WIRE and 1(ONE) 3.5mm2 THHN GROUND WIRE IN 20mm Ø ( $\frac{1}{2}$ ) PVC
4	230			SPARE					20 AT 2P, BOLT ON	
				TOTAL	1	13.48		3,100		

IT = (3,100 VA / 230 V) = 13.48

LPP - MAIN CIRCUIT BREAKER USE: 40 AT 2P CB BOLT-ON

SERVICE ENTRANCE

USE: 2 - 8.0 mm<sup>2</sup> THHN WIRE & 1 - 8.0mm<sup>2</sup> TW WIRE

IN 25 mm Ø PVC PIPE

FEED FROM:

EXISTING PANEL BOARD OF COVERED COURT

TAP TO EXISTING PANEL BOARD OF COVERED COURT - USE : 2-8.0mm² THHN 1-8.0mm² TW (GW) IN 25mmØ PVC LPP-STAGE 40AT 2P, 230V 20A,2P 20A,2P (2)20A,2P 20A,2P GROUNDING 1-8.0mm2 TW

SCHEDULE OF LOADS

SCALE: NTS

PANEL BOARD DETAILS

APPROVED BY :

SCALE1:100m.

SHEET NO.

SHEET CONTENT

Republika ng Pilipinas Lungsod ng Quezon CITY ENGINEERING DEPARTMENT

PROJECT TITLE: RAWN BY : mnm/brgz OATE: OCT. 07, 2020 PROPOSED CONSTRUCTION OF STAGE AT RAMON MAGSAYSAY HIGH SCHOOL CHECKED BY: BARANGAY PALIGSAHAN, DISTRICT 4, QUEZON CITY REVISION NO.:

ENGR. LEO S. DEL ROSARIO HEAD , PLANNING & PROGRAMMING DIVISION

SUBMITTED BY


ENGR. ISACANI R. VERZOSA, JR.

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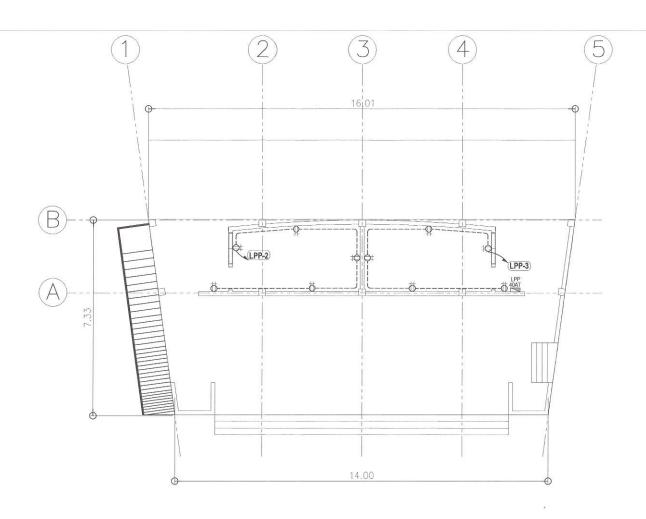
RECOMMENDING APPROVAL:

POWER LAYOUT PLAN HON. MA. JOSEFINA G. BELMONTE CITY MAYOR, QUEZON CITY

EL-02

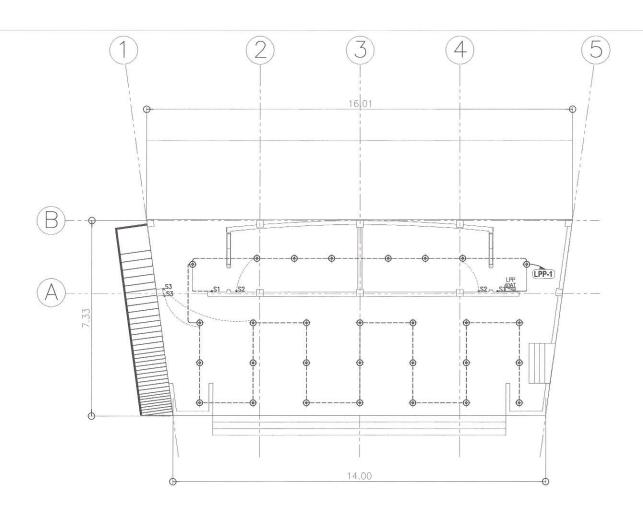

- 1										
	1 STAG	STAGE LIGHTING LAYOUT PLAN SCALE1:100m.								
	THECITY		PROJECT TITLE:	DRAWN BY : mnm/brgz	SUBMITTED BY:	RECOMMENDING APPROVAL:	APPROVED BY :	SHEET CONTENT	SHEET NO.	
		Republika ng Pilipinas Lungsod ng Quezon CITY ENGINEERING DEPARTMENT	PROPOSED CONSTRUCTION OF STAGE AT RAMON MAGSAYSAY HIGH SCHOOL	DATE : OCT. 07, 2020 CHECKED BY:	ENGR. LEO S. DEL ROSARIO	ENGR. ISAGANI R. VERZOSA. JR.	HON. MA. JOSEFINA G. BELMONTE	LIGHTING LAYOUT PLAN	EL-03	
1	EZON CT		BARANGAY PALIGSAHAN, DISTRICT 4, QUEZON CITY	REVISION NO.:	HEAD , PLANNING & PROGRAMMING DIVISION	OIC, CITY ENGINEERING DEPARTMENT	CITY MAYOR , QUEZON CITY			



1	STAGE	<b>POWER</b>	LAYOUT PLAN	1
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SCALE1:100m.

OTHECITY	
[5 ] R	СП
PUEZON CIA	

Republika ng Pilipinas Lungsod ng Quezon XITY ENGINEERING DEPARTMENT

PROJECT TITLE :	DRAWN BY : mnm/brgz
PROPOSED CONSTRUCTION OF STAGE	DATE : OCT. 07, 2020
AT RAMON MAGSAYSAY HIGH SCHOOL	CHECKED BY:
BARANGAY PALIGSAHAN, DISTRICT 4, QUEZON CITY	REVISION NO.:

RAWN BY: mnm/brgz	SUBMITTED BY:
ATE: OCT. 07, 2020	( \ \ \ \ \ \ \ \ \ \ \ \ \ \ \ \ \ \ \
HECKED BY:	ENGR. LEO S. DEL ROSARIO
EVISION NO.:	HEAD , PLANNING & PROGRAMMING DIVISION

RECOMMENDING APPROVAL:	APPROVED BY :	SHEET CONTENT	SHEET NO.
ENGR. ISAGANI R. VERZOSA, JR. OIC, CITY ENGINEERING DEPARTMENT	HON. MA. JOSEFINA G. BELMONTE	POWER LAYOUT PLAN	EL-04