

PHILIPPINE BIDDING DOCUMENTS

Procurement of INFRASTRUCTURE PROJECTS

Government of the Republic of the Philippines

**PROPOSED REHABILITATION OF ELECTRICAL SYSTEM
AT JUDGE FELICIANO BELMONTE SR. HIGH SCHOOL**

**Project number:
23-00196**

**Sixth Edition
July 2020**

Preface

These Philippine Bidding Documents (PBDs) for the procurement of Infrastructure Projects (hereinafter referred to also as the “Works”) through Competitive Bidding have been prepared by the Government of the Philippines for use by all branches, agencies, departments, bureaus, offices, or instrumentalities of the government, including government-owned and/or -controlled corporations, government financial institutions, state universities and colleges, local government units, and autonomous regional government. The procedures and practices presented in this document have been developed through broad experience, and are for mandatory use in projects that are financed in whole or in part by the Government of the Philippines or any foreign government/foreign or international financing institution in accordance with the provisions of the 2016 revised Implementing Rules and Regulations (IRR) of Republic Act (RA) No. 9184.

The PBDs are intended as a model for admeasurements (unit prices or unit rates in a bill of quantities) types of contract, which are the most common in Works contracting.

The Bidding Documents shall clearly and adequately define, among others: (i) the objectives, scope, and expected outputs and/or results of the proposed contract; (ii) the eligibility requirements of Bidders; (iii) the expected contract duration; and (iv) the obligations, duties, and/or functions of the winning Bidder.

Care should be taken to check the relevance of the provisions of the PBDs against the requirements of the specific Works to be procured. If duplication of a subject is inevitable in other sections of the document prepared by the Procuring Entity, care must be exercised to avoid contradictions between clauses dealing with the same matter.

Moreover, each section is prepared with notes intended only as information for the Procuring Entity or the person drafting the Bidding Documents. They shall not be included in the final documents. The following general directions should be observed when using the documents:

- a. All the documents listed in the Table of Contents are normally required for the procurement of Infrastructure Projects. However, they should be adapted as necessary to the circumstances of the particular Project.
- b. Specific details, such as the “*name of the Procuring Entity*” and “*address for bid submission*,” should be furnished in the Instructions to Bidders, Bid Data Sheet, and Special Conditions of Contract. The final documents should contain neither blank spaces nor options.
- c. This Preface and the footnotes or notes in italics included in the Invitation to Bid, BDS, General Conditions of Contract, Special Conditions of Contract, Specifications, Drawings, and Bill of Quantities are not part of the text of the final document, although they contain instructions that the Procuring Entity should strictly follow.
- d. The cover should be modified as required to identify the Bidding Documents as to the names of the Project, Contract, and Procuring Entity, in addition to date of issue.

- e. Modifications for specific Procurement Project details should be provided in the Special Conditions of Contract as amendments to the Conditions of Contract. For easy completion, whenever reference has to be made to specific clauses in the Bid Data Sheet or Special Conditions of Contract, these terms shall be printed in bold typeface on Sections I (Instructions to Bidders) and III (General Conditions of Contract), respectively.
- f. For guidelines on the use of Bidding Forms and the procurement of Foreign-Assisted Projects, these will be covered by a separate issuance of the Government Procurement Policy Board.

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Glossary of Terms, Abbreviations, and Acronyms

ABC – Approved Budget for the Contract.

ARCC – Allowable Range of Contract Cost.

BAC – Bids and Awards Committee.

Bid – A signed offer or proposal to undertake a contract submitted by a bidder in response to and in consonance with the requirements of the bidding documents. Also referred to as *Proposal* and *Tender*. (2016 revised IRR, Section 5[c])

Bidder – Refers to a contractor, manufacturer, supplier, distributor and/or consultant who submits a bid in response to the requirements of the Bidding Documents. (2016 revised IRR, Section 5[d])

Bidding Documents – The documents issued by the Procuring Entity as the bases for bids, furnishing all information necessary for a prospective bidder to prepare a bid for the Goods, Infrastructure Projects, and/or Consulting Services required by the Procuring Entity. (2016 revised IRR, Section 5[e])

BIR – Bureau of Internal Revenue.

BSP – Bangko Sentral ng Pilipinas.

CDA – Cooperative Development Authority.

Consulting Services – Refer to services for Infrastructure Projects and other types of projects or activities of the GOP requiring adequate external technical and professional expertise that are beyond the capability and/or capacity of the GOP to undertake such as, but not limited to: (i) advisory and review services; (ii) pre-investment or feasibility studies; (iii) design; (iv) construction supervision; (v) management and related services; and (vi) other technical services or special studies. (2016 revised IRR, Section 5[i])

Contract – Refers to the agreement entered into between the Procuring Entity and the Supplier or Manufacturer or Distributor or Service Provider for procurement of Goods and Services; Contractor for Procurement of Infrastructure Projects; or Consultant or Consulting Firm for Procurement of Consulting Services; as the case may be, as recorded in the Contract Form signed by the parties, including all attachments and appendices thereto and all documents incorporated by reference therein.

Contractor – is a natural or juridical entity whose proposal was accepted by the Procuring Entity and to whom the Contract to execute the Work was awarded. Contractor as used in these Bidding Documents may likewise refer to a supplier, distributor, manufacturer, or consultant.

CPI – Consumer Price Index.

DOLE – Department of Labor and Employment.

DTI – Department of Trade and Industry.

Foreign-funded Procurement or Foreign-Assisted Project – Refers to procurement whose funding source is from a foreign government, foreign or international financing institution as specified in the Treaty or International or Executive Agreement. (2016 revised IRR, Section 5[b]).

GFI – Government Financial Institution.

GOCC – Government-owned and/or –controlled corporation.

Goods – Refer to all items, supplies, materials and general support services, except Consulting Services and Infrastructure Projects, which may be needed in the transaction of public businesses or in the pursuit of any government undertaking, project or activity, whether in the nature of equipment, furniture, stationery, materials for construction, or personal property of any kind, including non-personal or contractual services such as the repair and maintenance of equipment and furniture, as well as trucking, hauling, janitorial, security, and related or analogous services, as well as procurement of materials and supplies provided by the Procuring Entity for such services. The term “related” or “analogous services” shall include, but is not limited to, lease or purchase of office space, media advertisements, health maintenance services, and other services essential to the operation of the Procuring Entity. (2016 revised IRR, Section 5[r])

GOP – Government of the Philippines.

Infrastructure Projects – Include the construction, improvement, rehabilitation, demolition, repair, restoration or maintenance of roads and bridges, railways, airports, seaports, communication facilities, civil works components of information technology projects, irrigation, flood control and drainage, water supply, sanitation, sewerage and solid waste management systems, shore protection, energy/power and electrification facilities, national buildings, school buildings, hospital buildings, and other related construction projects of the government. Also referred to as *civil works or works*. (2016 revised IRR, Section 5[u])

LGUs – Local Government Units.

NFCC – Net Financial Contracting Capacity.

NGA – National Government Agency.

PCAB – Philippine Contractors Accreditation Board.

PhilGEPS - Philippine Government Electronic Procurement System.

Procurement Project – refers to a specific or identified procurement covering goods, infrastructure project or consulting services. A Procurement Project shall be described, detailed, and scheduled in the Project Procurement Management Plan prepared by the agency which shall be consolidated in the procuring entity's Annual Procurement Plan. (GPPB Circular No. 06-2019 dated 17 July 2019)

PSA – Philippine Statistics Authority.

SEC – Securities and Exchange Commission.

SLCC – Single Largest Completed Contract.

UN – United Nations.

Section I. Invitation to Bid

Notes on the Invitation to Bid

The Invitation to Bid (IB) provides information that enables potential Bidders to decide whether to participate in the procurement at hand. The IB shall be posted in accordance with Section 21.2 of the 2016 revised IRR of RA No. 9184.

Apart from the essential items listed in the Bidding Documents, the IB should also indicate the following:

- a. The date of availability of the Bidding Documents, which shall be from the time the IB is first advertised/posted until the deadline for the submission and receipt of bids;
- b. The place where the Bidding Documents may be acquired or the website where it may be downloaded;
- c. The deadline for the submission and receipt of bids; and
- d. Any important bid evaluation criteria.

The IB should be incorporated into the Bidding Documents. The information contained in the IB must conform to the Bidding Documents and in particular to the relevant information in the Bid Data Sheet.



REPUBLIC OF THE PHILIPPINES
QUEZON CITY GOVERNMENT
BIDS AND AWARDS COMMITTEE FOR INFRASTRUCTURE & CONSULTANCY
2nd floor, Finance Building, Procurement Department, Quezon City Hall Complex, Elliptical Road, Quezon City



December 06, 2023

Invitation to Bid

No.	Project No.	Project Name	Location	Amount	Duration Cal. Days	Office	Source Fund
<u>Buildings – Small A</u>							
1	23-0144B	Proposed Rehabilitation of Plumbing and Sanitary System at West Fairview High School	Fairview	759,392.35	30	Engineering Department	Special Education Fund
<u>Buildings – Small B</u>							
2	23-00182	Quezon City Hall Solar PV Rehabilitation and Restoration in Civic Center Building E	Central	1,366,103.61	30	Engineering Department	Green Fund
3	23-00183	Proposed Installation of Fire Exits and Rehabilitation of Roof Eaves / Canopy at Tandang Sora Elementary School	Tandang Sora	1,907,681.16	60	Engineering Department	Special Education Fund
4	23-00184	Proposed Construction of Perimeter Fence at Bago Bantay Elementary School	Ramon Magsaysay	2,457,519.94	60	Engineering Department	Special Education Fund
5	23-00185	Quezon City Hall Solar PV Rehabilitation and Restoration in Main Building and Legislative Building	Central	2,729,857.96	60	Engineering Department	Green Fund
6	23-00186	Proposed Upgrading of Electrical System at Balingasa Elementary School	Balingasa	3,885,013.26	60	Engineering Department	Special Education Fund
7	23-00187	Proposed Replacement of Doors and Windows at Damong Maliit Elementary School	Nagkaisang Nayon	4,304,801.11	60	Engineering Department	Special Education Fund
8	23-00188	Proposed Rehabilitation of Water Supply System and Comfort Rooms at Ernesto Rondon High School	Project 6	4,422,445.41	60	Engineering Department	Special Education Fund
9	23-00189	Proposed Upgrading of Electrical System at San Diego Elementary School	Batasan Hills	4,973,139.87	60	Engineering Department	Special Education Fund
10	23-00190	Quezon City Hall Solar PV Rehabilitation and Restoration in Treasury Building South	Central	5,120,598.15	90	Engineering Department	Green Fund
11	23-00191	Proposed Upgrading of Electrical System at Manuel Luis Quezon Elementary School	Commonwealth	6,362,598.21	30	Engineering Department	Special Education Fund
12	23-00192	Proposed Construction of Connecting Bridge and Rehabilitation of Flora Ylagan High School	Pinyahan	9,737,822.47	150	Engineering Department	Special Education Fund

13	23-00193	Proposed Rehabilitation of Drainage System at Ramon Magsaysay Cubao High School	Pinagkaisahan	10,743,676.64	60	Engineering Department	Special Education Fund
14	23-00194	Proposed Rehabilitation of Comfort Rooms at GSIS Village Elementary School	Sangandaan	11,223,072.07	150	Engineering Department	Special Education Fund
15	23-00195	Proposed Upgrading of Electrical System at Placido Del Mundo Elementary School	Talipapa	11,543,755.95	150	Engineering Department	Special Education Fund
16	23-00196	Proposed Rehabilitation of Electrical System at Judge Feliciano Belmonte Sr. High School	Holy Spirit	16,792,451.40	150	Engineering Department	Special Education Fund
17	23-00197	Proposed Installation of Street Lights at Various Street	Batasan Hills	18,179,005.62	60	Engineering Department	20% CDF – Continuing Appropriation
18	23-00198	Proposed Upgrading of Plumbing System and Rehabilitation of Comfort Rooms at San Antonio Elementary School	Katipunan	20,971,311.15	150	Engineering Department	Special Education Fund
<u>Buildings – Medium A</u>							
19	23-00199	Proposed Installation of Street Lights at Various Street	Holy Spirit	45,445,874.36	150	Engineering Department	20% CDF – Continuing Appropriation
20	23-00200	Proposed Installation of Street Lights on Various Barangays of Quezon City	District IV	53,845,231.88	120	Engineering Department	20% CDF – Continuing Appropriation
21	23-00201	Proposed Mechanical Retrofitting of Treasury Building Including Rehabilitation of Façade	Central	34,424,453.96	180	Engineering Department	Engineering-Continuing Appropriation

1. The **QUEZON CITY LOCAL GOVERNMENT**, through *funding source of various years* intends to apply the sum stated above being the Approved Budget for the Contract (ABC) to payments under the contract *for the above stated Projects*. Bids received in excess of the ABC shall be automatically rejected at bid opening.
2. The **QUEZON CITY LOCAL GOVERNMENT** now invites bids for the above Procurement Project. Completion of the Works is required *as stated above*. Bidders should have completed a contract similar to the Project. The description of an eligible bidder is contained in the Bidding Documents, particularly, in Section II (Instructions to Bidders).
3. Bidding will be conducted through open competitive bidding procedures using non-discretionary “*pass/fail*” criterion as specified in the 2016 revised Implementing Rules and Regulations (IRR) of Republic Act (RA) No. 9184.
4. Interested bidders may obtain further information from **QUEZON CITY LOCAL GOVERNMENT – BAC Secretariat** and inspect the Bidding Documents at the address given below *weekdays from 8:00 am. – 5:00 p.m.*
5. A complete set of Bidding Documents may be acquired by interested bidders on **December 07, 2023 (Thursday)** from given address and website/s below *and upon payment of a non-refundable fee for the Bidding Documents, pursuant to the latest Guidelines issued by the*

GPPB. The Procuring Entity shall allow the bidder to present its proof of payment for the fees presented in person.

STANDARD RATES:

Approved Budget for the Contract	Maximum Cost of Bidding Documents (in Philippine Peso)
500,000 and below	500.00
More than 500,000 up to 1 Million	1,000.00
More than 1 Million up to 5 Million	5,000.00
More than 5 Million up to 10 Million	10,000.00
More than 10 Million up to 50 Million	25,000.00
More than 50 Million up to 500 Million	50,000.00
More than 500 Million	75,000.00

The following are the requirements for purchase of Bidding Documents;

1. PhilGEPS Registration Certificate (Platinum – 3 Pages)
2. Document Request List (DRL)
3. Authorization to purchase bidding documents
 - 3.1 Secretary's Certificate (for corporation)
 - 3.2 Special Power of Attorney (for sole proprietorship)
4. Notarized Joint Venture Agreement (if applicable)
5. Letter of Intent

It must be duly received by the BAC Secretariat at 2nd Floor, Procurement Department, Finance Building, Quezon City Hall Compound.

6. The **QC- BAC- INFRASTRUCTURE & CONSULTANCY** will hold a Pre-Bid Conference¹ on **December 15, 2023 at 10:00 AM at 2nd Floor, Procurement Department-Bidding Room, Finance Building, Quezon City Hall Compound** or we encourage the prospective bidders to join through our **Virtual Conference (ZOOM APP)** which shall be open to prospective bidders.

Virtual Conference (ZOOM APP)

Meeting ID: 854 9489 0133

Password: 273320

7. Bids must be duly received by the BAC Secretariat through manual submission at the office address as indicated below, on or before **December 27, 2023 – 9:00 AM**. Late bids shall not be accepted.
8. All bids must be accompanied by a bid security in any of the acceptable forms and in the amount stated in **ITB Clause 16**.
9. Bid opening shall be on **December 27, 2023 – 10:00 AM at 2nd Floor, Procurement Department-Bidding Room, Finance Building, Quezon City Hall Compound** and/or via Zoom. Bids will be opened in the presence of the bidders' representatives who choose to attend the activity.

Virtual Conference (ZOOM APP)

Meeting ID: 810 3646 5257

Password: 201522

¹ May be deleted in case the ABC is less than One Million Pesos (PhP1,000,000) where the Procuring Entity may not hold a pre-bid conference.

10. The **Quezon City Local Government** reserves the right to reject any and all bids, declare a failure of bidding, or not award the contract at any time prior to contract award in accordance with Sections 35.6 and 41 of the 2016 revised Implementing Rules and Regulations (IRR) of RA No. 9184, without thereby incurring any liability to the affected bidder or bidders.
11. For further information, please refer to:

ATTY. DOMINIC B. GARCIA

OIC, Procurement Department
2nd Floor, Procurement Department,
Finance Building, Quezon City Hall Compound
Elliptical Road, Barangay Central Diliman, Quezon City.
Tel. No. (02)8988-4242 loc. 8506/8710
Email Add: bacinfra.procurement@quezoncity.gov.ph
Website: www.quezoncity.gov.ph

12. You may visit the following websites:

For downloading of Bidding Documents: <https://quezoncity.gov.ph/public-notices/procurement/>

By:



ATTY. SHERRY R. GONZALVO
Vice Chairperson, BAC Infra and Consultancy

Section II. Instructions to Bidders

Notes on the Instructions to Bidders

This Section on the Instruction to Bidders (ITB) provides the information necessary for bidders to prepare responsive bids, in accordance with the requirements of the Procuring Entity. It also provides information on bid submission, eligibility check, opening and evaluation of bids, post-qualification, and on the award of contract.

1. Scope of Bid

The Procuring Entity, **Quezon City Government** invites Bids for the **PROPOSED REHABILITATION OF ELECTRICAL SYSTEM AT JUDGE FELICIANO BELMONTE SR. HIGH SCHOOL**, with Project Identification Number **23-00196**.

[Note: The Project Identification Number is assigned by the Procuring Entity based on its own coding scheme and is not the same as the PhilGEPS reference number, which is generated after the posting of the bid opportunity on the PhilGEPS website.]

The Procurement Project (referred to herein as “Project”) is for the construction of Works, as described in Section VI (Specifications).

2. Funding Information

2.1. The GOP through the source of funding as indicated below for **2023** in the amount of **Sixteen Million Seven Hundred Ninety Two Thousand Four Hundred Fifty-One Pesos and 40/100 Cts. (P 16,792,451.40)**.

2.2. The source of funding is:

a. LGUs, the Annual or Supplemental Budget, as approved by the Sanggunian.

3. Bidding Requirements

The Bidding for the Project shall be governed by all the provisions of RA No. 9184 and its 2016 revised IRR, including its Generic Procurement Manual and associated policies, rules and regulations as the primary source thereof, while the herein clauses shall serve as the secondary source thereof.

Any amendments made to the IRR and other GPPB issuances shall be applicable only to the ongoing posting, advertisement, or invitation to bid by the BAC through the issuance of a supplemental or bid bulletin.

The Bidder, by the act of submitting its Bid, shall be deemed to have inspected the site, determined the general characteristics of the contracted Works and the conditions for this Project, such as the location and the nature of the work; (b) climatic conditions; (c) transportation facilities; (c) nature and condition of the terrain, geological conditions at the site communication facilities, requirements, location and availability of construction aggregates and other materials, labor, water, electric power and access roads; and (d) other factors that may affect the cost, duration and execution or implementation of the contract, project, or work and examine all instructions, forms, terms, and project requirements in the Bidding Documents.

4. Corrupt, Fraudulent, Collusive, Coercive, and Obstructive Practices

The Procuring Entity, as well as the Bidders and Contractors, shall observe the highest standard of ethics during the procurement and execution of the contract. They or through an agent shall not engage in corrupt, fraudulent, collusive, coercive, and

obstructive practices defined under Annex “I” of the 2016 revised IRR of RA No. 9184 or other integrity violations in competing for the Project.

5. Eligible Bidders

- 5.1. Only Bids of Bidders found to be legally, technically, and financially capable will be evaluated.
- 5.2. The Bidder must have an experience of having completed a Single Largest Completed Contract (SLCC) that is similar to this Project, equivalent to at least fifty percent (50%) of the ABC adjusted, if necessary, by the Bidder to current prices using the PSA’s CPI, except under conditions provided for in Section 23.4.2.4 of the 2016 revised IRR of RA No. 9184.

A contract is considered to be “similar” to the contract to be bid if it has the major categories of work stated in the **BDS**.

- 5.3. For Foreign-funded Procurement, the Procuring Entity and the foreign government/foreign or international financing institution may agree on another track record requirement, as specified in the Bidding Document prepared for this purpose.
- 5.4. The Bidders shall comply with the eligibility criteria under Section 23.4.2 of the 2016 IRR of RA No. 9184.

6. Origin of Associated Goods

There is no restriction on the origin of Goods other than those prohibited by a decision of the UN Security Council taken under Chapter VII of the Charter of the UN.

7. Subcontracts

- 7.1. The Bidder may subcontract portions of the Project to the extent allowed by the Procuring Entity as stated herein, but in no case more than fifty percent (50%) of the Project.

The Procuring Entity has prescribed that:

a. Subcontracting is not allowed.

- 7.1. *[If Procuring Entity has determined that subcontracting is allowed during the bidding , state:]* The Bidder must submit together with its Bid the documentary requirements of the subcontractor(s) complying with the eligibility criterial stated in **ITB** Clause 5 in accordance with Section 23.4 of the 2016 revised IRR of RA No. 9184 pursuant to Section 23.1 thereof.
- 7.2. *[If subcontracting is allowed during the contract implementation stage, state:]* The Supplier may identify its subcontractor during the contract implementation stage. Subcontractors identified during the bidding may be changed during the implementation of this Contract. Subcontractors must submit the documentary

requirements under Section 23.1 of the 2016 revised IRR of RA No. 9184 and comply with the eligibility criteria specified in **ITB** Clause 5 to the implementing or end-user unit.

- 7.3. Subcontracting of any portion of the Project does not relieve the Contractor of any liability or obligation under the Contract. The Supplier will be responsible for the acts, defaults, and negligence of any subcontractor, its agents, servants, or workmen as fully as if these were the Contractor's own acts, defaults, or negligence, or those of its agents, servants, or workmen.

8. Pre-Bid Conference

The Procuring Entity will hold a pre-bid conference for this Project on the specified date and time and either at its physical address on **December 15, 2023, 10:00 A.M. at 2nd Floor, Procurement Department-Bidding Room, Finance Building, Quezon City Hall Compound** and/or we encourage the prospective bidders to join through our Virtual Conference (ZOOM APP) Meeting ID: 854 9489 0133 Password: 273320

9. Clarification and Amendment of Bidding Documents

Prospective bidders may request for clarification on and/or interpretation of any part of the Bidding Documents. Such requests must be in writing and received by the Procuring Entity, either at its given address or through electronic mail indicated in the **IB**, at least ten (10) calendar days before the deadline set for the submission and receipt of Bids.

10. Documents Comprising the Bid: Eligibility and Technical Components

- 10.1. The first envelope shall contain the eligibility and technical documents of the Bid as specified in **Section IX. Checklist of Technical and Financial Documents**.
- 10.2. If the eligibility requirements or statements, the bids, and all other documents for submission to the BAC are in foreign language other than English, it must be accompanied by a translation in English, which shall be authenticated by the appropriate Philippine foreign service establishment, post, or the equivalent office having jurisdiction over the foreign bidder's affairs in the Philippines. For Contracting Parties to the Apostille Convention, only the translated documents shall be authenticated through an apostille pursuant to GPPB Resolution No. 13-2019 dated 23 May 2019. The English translation shall govern, for purposes of interpretation of the bid.
- 10.3. A valid PCAB License is required, and in case of joint ventures, a valid special PCAB License, and registration for the type and cost of the contract for this Project. Any additional type of Contractor license or permit shall be indicated in the **BDS**.
- 10.4. A List of Contractor's key personnel (e.g., Project Manager, Project Engineers, Materials Engineers, and Foremen) assigned to the contract to be bid, with their

complete qualification and experience data shall be provided. These key personnel must meet the required minimum years of experience set in the **BDS**.

- 10.5. A List of Contractor's major equipment units, which are owned, leased, and/or under purchase agreements, supported by proof of ownership, certification of availability of equipment from the equipment lessor/vendor for the duration of the project, as the case may be, must meet the minimum requirements for the contract set in the **BDS**.

11. Documents Comprising the Bid: Financial Component

- 11.1. The second bid envelope shall contain the financial documents for the Bid as specified in **Section IX. Checklist of Technical and Financial Documents**.
- 11.2. Any bid exceeding the ABC indicated in paragraph 1 of the **IB** shall not be accepted.
- 11.3. For Foreign-funded procurement, a ceiling may be applied to bid prices provided the conditions are met under Section 31.2 of the 2016 revised IRR of RA No. 9184.

12. Alternative Bids

Bidders shall submit offers that comply with the requirements of the Bidding Documents, including the basic technical design as indicated in the drawings and specifications. Unless there is a value engineering clause in the **BDS**, alternative Bids shall not be accepted.

13. Bid Prices

All bid prices for the given scope of work in the Project as awarded shall be considered as fixed prices, and therefore not subject to price escalation during contract implementation, except under extraordinary circumstances as determined by the NEDA and approved by the GPPB pursuant to the revised Guidelines for Contract Price Escalation guidelines.

14. Bid and Payment Currencies

- 14.1. Bid prices may be quoted in the local currency or tradeable currency accepted by the BSP at the discretion of the Bidder. However, for purposes of bid evaluation, Bids denominated in foreign currencies shall be converted to Philippine currency based on the exchange rate as published in the BSP reference rate bulletin on the day of the bid opening.
- 14.2. *Payment of the contract price shall be made in:*
 - a. Philippine Pesos.

15. Bid Security

- 15.1. The Bidder shall submit a Bid Securing Declaration or any form of Bid Security in the amount indicated in the **BDS**, which shall be not less than the percentage of the ABC in accordance with the schedule in the **BDS**.
- 15.2. The Bid and bid security **in no case shall exceed One Hundred Twenty (120) calendar days from the date of opening of bids, unless duly extended by the bidder upon the request of the Head of the Procuring Entity (HoPE) of the Quezon City Local Government**. Any bid not accompanied by an acceptable bid security shall be rejected by the Procuring Entity as non-responsive.

16. Sealing and Marking of Bids

Each Bidder shall submit one copy of the first and second components of its Bid.

The Procuring Entity may request additional hard copies and/or electronic copies of the Bid. However, failure of the Bidders to comply with the said request shall not be a ground for disqualification.

If the Procuring Entity allows the submission of bids through online submission to the given website or any other electronic means, the Bidder shall submit an electronic copy of its Bid, which must be digitally signed. An electronic copy that cannot be opened or is corrupted shall be considered non-responsive and, thus, automatically disqualified.

17. Deadline for Submission of Bids

The Bidders shall submit on the specified date and time and either at its physical address or through online submission as indicated in paragraph 5 of the **IB**.

18. Opening and Preliminary Examination of Bids

- 18.1. The BAC shall open the Bids in public at the time, on the date, and at the place specified in paragraph 9 of the **IB**. The Bidders' representatives who are present shall sign a register evidencing their attendance. In case videoconferencing, webcasting or other similar technologies will be used, attendance of participants shall likewise be recorded by the BAC Secretariat.

In case the Bids cannot be opened as scheduled due to justifiable reasons, the rescheduling requirements under Section 29 of the 2016 revised IRR of RA No. 9184 shall prevail.

- 18.2. The preliminary examination of Bids shall be governed by Section 30 of the 2016 revised IRR of RA No. 9184.

19. Detailed Evaluation and Comparison of Bids

- 19.1. The Procuring Entity's BAC shall immediately conduct a detailed evaluation of all Bids rated "*passed*" using non-discretionary pass/fail criteria. The BAC

shall consider the conditions in the evaluation of Bids under Section 32.2 of 2016 revised IRR of RA No. 9184.

- 19.2. If the Project allows partial bids, all Bids and combinations of Bids as indicated in the **BDS** shall be received by the same deadline and opened and evaluated simultaneously so as to determine the Bid or combination of Bids offering the lowest calculated cost to the Procuring Entity. Bid Security as required by **ITB** Clause 15 shall be submitted for each contract (lot) separately.
- 19.3. In all cases, the NFCC computation pursuant to Section 23.4.2.6 of the 2016 revised IRR of RA No. 9184 must be sufficient for the total of the ABCs for all the lots participated in by the prospective Bidder.

20. Post Qualification

Within a non-extendible period of five (5) calendar days from receipt by the Bidder of the notice from the BAC that it submitted the Lowest Calculated Bid, the Bidder shall submit its latest income and business tax returns filed and paid through the BIR Electronic Filing and Payment System (eFPS), and other appropriate licenses and permits required by law and stated in the **BDS**.

21. Signing of the Contract

The documents required in Section 37.2 of the 2016 revised IRR of RA No. 9184 shall form part of the Contract. Additional Contract documents are indicated in the **BDS**.

Section III. Bid Data Sheet

Notes on the Bid Data Sheet (BDS)

The Bid Data Sheet (BDS) consists of provisions that supplement, amend, or specify in detail, information, or requirements included in the ITB found in Section II, which are specific to each procurement.

This Section is intended to assist the Procuring Entity in providing the specific information in relation to corresponding clauses in the ITB and has to be prepared for each specific procurement.

The Procuring Entity should specify in the BDS information and requirements specific to the circumstances of the Procuring Entity, the processing of the procurement, and the bid evaluation criteria that will apply to the Bids. In preparing the BDS, the following aspects should be checked:

- a. Information that specifies and complements provisions of the ITB must be incorporated.
- b. Amendments and/or supplements, if any, to provisions of the ITB as necessitated by the circumstances of the specific procurement, must also be incorporated.

Bid Data Sheet

ITB Clause																									
5.2	For this purpose, similar contracts shall refer to contracts which have the same major categories of work.																								
7.1	Subcontracting is not allowed.																								
10.3	<i>No additional contractor license or permit is required</i> <i>In addition, eligible bidders shall qualify or comply with the following:</i> 1. Bidders with valid Philippine Contractors Accreditation Board (PCAB) Type Buildings – Small B																								
10.4	<p>The minimum work experience requirements for key personnel are the following:</p> <table><tr><th>Qty.</th><th>Key Personnel</th><th>General Experience</th><th>Relevant Experience</th></tr><tr><td>1</td><td>Project in Charge (Project Engineer)</td><td>3 years</td><td>3 years</td></tr><tr><td>1</td><td>General Foreman</td><td>3 years</td><td>3 years</td></tr><tr><td>1</td><td>Trade Engineer/Leadman for Civil Works</td><td>3 years</td><td>3 years</td></tr><tr><td>1</td><td>Trade Engineer/Leadman for Electrical Works</td><td>3 years</td><td>3 years</td></tr><tr><td>1</td><td>Safety Officer</td><td>3 years</td><td>3 years</td></tr></table> <i>In addition, the bidder must execute an affidavit of undertaking duly notarized stating that the foregoing personnel shall perform work exclusively for the project until its completion. Please see attached bid forms.</i>	Qty.	Key Personnel	General Experience	Relevant Experience	1	Project in Charge (Project Engineer)	3 years	3 years	1	General Foreman	3 years	3 years	1	Trade Engineer/Leadman for Civil Works	3 years	3 years	1	Trade Engineer/Leadman for Electrical Works	3 years	3 years	1	Safety Officer	3 years	3 years
Qty.	Key Personnel	General Experience	Relevant Experience																						
1	Project in Charge (Project Engineer)	3 years	3 years																						
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1	Trade Engineer/Leadman for Electrical Works	3 years	3 years																						
1	Safety Officer	3 years	3 years																						
10.5	<p>The minimum major equipment requirements are the following:</p> <table><tr><th>Equipment</th><th>Capacity</th><th>Number of Units</th></tr><tr><td>Dump Truck</td><td>12 yd³</td><td>1</td></tr><tr><td>Chipping Gun</td><td></td><td>1</td></tr></table> <i>In addition, the bidder must execute an affidavit of undertaking duly notarized stating that the foregoing equipment shall be used exclusively for the project until its completion. Please see attached bid forms.</i>	Equipment	Capacity	Number of Units	Dump Truck	12 yd ³	1	Chipping Gun		1															
Equipment	Capacity	Number of Units																							
Dump Truck	12 yd ³	1																							
Chipping Gun		1																							
12	<i>[Insert Value Engineering clause if allowed.]</i>																								
15.1	The bid security shall be in the form of a Bid Securing Declaration with project number, or any of the following forms and amounts:																								

	<p>a) The amount of not less than Php 335,849.03 or equivalent to two percent (2%) of ABC if bid security is in cash, cashier's/manager's check, bank draft/guarantee or irrevocable letter of credit; or</p> <p>b) The amount of not less than Php 839,622.57 or equivalent to five percent (5%) of ABC if bid security is in Surety Bond.</p>
19.2	Partial bid is not allowed. The infrastructure project is packaged in a single lot and the lot shall not be divided into sub-lots for the purpose of bidding, evaluation, and contract award.
20	No additional requirement.
21	Additional Contract Documents relevant to the Project as required: 1. Construction Schedule and S-curve, 2. Manpower Schedule, 3. Construction Methods, 4. Equipment Utilization Schedule, 5. PERT/CPM or other acceptable tools of project scheduling, shall be included in the submission of Technical Proposal.

Section IV. General Conditions of Contract

Notes on the General Conditions of Contract

The General Conditions of Contract (GCC) in this Section, read in conjunction with the Special Conditions of Contract in Section V and other documents listed therein, should be a complete document expressing all the rights and obligations of the parties.

Matters governing performance of the Contractor, payments under the contract, or matters affecting the risks, rights, and obligations of the parties under the contract are included in the GCC and Special Conditions of Contract.

Any complementary information, which may be needed, shall be introduced only through the Special Conditions of Contract.

1. Scope of Contract

This Contract shall include all such items, although not specifically mentioned, that can be reasonably inferred as being required for its completion as if such items were expressly mentioned herein. All the provisions of RA No. 9184 and its 2016 revised IRR, including the Generic Procurement Manual, and associated issuances, constitute the primary source for the terms and conditions of the Contract, and thus, applicable in contract implementation. Herein clauses shall serve as the secondary source for the terms and conditions of the Contract.

This is without prejudice to Sections 74.1 and 74.2 of the 2016 revised IRR of RA No. 9184 allowing the GPPB to amend the IRR, which shall be applied to all procurement activities, the advertisement, posting, or invitation of which were issued after the effectivity of the said amendment.

2. Sectional Completion of Works

If sectional completion is specified in the **Special Conditions of Contract (SCC)**, references in the Conditions of Contract to the Works, the Completion Date, and the Intended Completion Date shall apply to any Section of the Works (other than references to the Completion Date and Intended Completion Date for the whole of the Works).

3. Possession of Site

3.1 The Procuring Entity shall give possession of all or parts of the Site to the Contractor based on the schedule of delivery indicated in the **SCC**, which corresponds to the execution of the Works. If the Contractor suffers delay or incurs cost from failure on the part of the Procuring Entity to give possession in accordance with the terms of this clause, the Procuring Entity's Representative shall give the Contractor a Contract Time Extension and certify such sum as fair to cover the cost incurred, which sum shall be paid by Procuring Entity.

3.2 If possession of a portion is not given by the above date, the Procuring Entity will be deemed to have delayed the start of the relevant activities. The resulting adjustments in contract time to address such delay may be addressed through contract extension provided under Annex "E" of the 2016 revised IRR of RA No. 9184.

4. The Contractor's Obligations

The Contractor shall employ the key personnel named in the Schedule of Key Personnel indicating their designation, in accordance with **ITB** Clause 10.3 and specified in the **BDS**, to carry out the supervision of the Works.

The Procuring Entity will approve any proposed replacement of key personnel only if their relevant qualifications and abilities are equal to or better than those of the personnel listed in the Schedule.

5. Performance Security

- 5.1. Within ten (10) calendar days from receipt of the Notice of Award from the Procuring Entity but in no case later than the signing of the contract by both parties, the successful Bidder shall furnish the performance security in any of the forms prescribed in Section 39 of the 2016 revised IRR.
- 5.2. The Contractor, by entering into the Contract with the Procuring Entity, acknowledges the right of the Procuring Entity to institute action pursuant to RA No. 3688 against any subcontractor be they an individual, firm, partnership, corporation, or association supplying the Contractor with labor, materials and/or equipment for the performance of this Contract.

6. Site Investigation Reports

The Contractor, in preparing the Bid, shall rely on any Site Investigation Reports referred to in the SCC supplemented by any information obtained by the Contractor.

7. Warranty

- 7.1. In case the Contractor fails to undertake the repair works under Section 62.2.2 of the 2016 revised IRR, the Procuring Entity shall forfeit its performance security, subject its property(ies) to attachment or garnishment proceedings, and perpetually disqualify it from participating in any public bidding. All payables of the GOP in his favor shall be offset to recover the costs.
- 7.2. The warranty against Structural Defects/Failures, except that occasioned-on force majeure, shall cover the period from the date of issuance of the Certificate of Final Acceptance by the Procuring Entity. Specific duration of the warranty is found in the SCC.

8. Liability of the Contractor

Subject to additional provisions, if any, set forth in the SCC, the Contractor's liability under this Contract shall be as provided by the laws of the Republic of the Philippines.

If the Contractor is a joint venture, all partners to the joint venture shall be jointly and severally liable to the Procuring Entity.

9. Termination for Other Causes

Contract termination shall be initiated in case it is determined *prima facie* by the Procuring Entity that the Contractor has engaged, before, or during the implementation of the contract, in unlawful deeds and behaviors relative to contract acquisition and implementation, such as, but not limited to corrupt, fraudulent, collusive, coercive, and obstructive practices as stated in ITB Clause 4.

10. Dayworks

Subject to the guidelines on Variation Order in Annex “E” of the 2016 revised IRR of RA No. 9184, and if applicable as indicated in the **SCC**, the Dayworks rates in the Contractor’s Bid shall be used for small additional amounts of work only when the Procuring Entity’s Representative has given written instructions in advance for additional work to be paid for in that way.

11. Program of Work

- 11.1. The Contractor shall submit to the Procuring Entity’s Representative for approval the said Program of Work showing the general methods, arrangements, order, and timing for all the activities in the Works. The submissions of the Program of Work are indicated in the **SCC**.
- 11.2. The Contractor shall submit to the Procuring Entity’s Representative for approval an updated Program of Work at intervals no longer than the period stated in the **SCC**. If the Contractor does not submit an updated Program of Work within this period, the Procuring Entity’s Representative may withhold the amount stated in the **SCC** from the next payment certificate and continue to withhold this amount until the next payment after the date on which the overdue Program of Work has been submitted.

12. Instructions, Inspections and Audits

The Contractor shall permit the GOP or the Procuring Entity to inspect the Contractor’s accounts and records relating to the performance of the Contractor and to have them audited by auditors of the GOP or the Procuring Entity, as may be required.

13. Advance Payment

The Procuring Entity shall, upon a written request of the Contractor which shall be submitted as a Contract document, make an advance payment to the Contractor in an amount not exceeding fifteen percent (15%) of the total contract price, to be made in lump sum, or at the most two installments according to a schedule specified in the **SCC**, subject to the requirements in Annex “E” of the 2016 revised IRR of RA No. 9184.

14. Progress Payments

The Contractor may submit a request for payment for Work accomplished. Such requests for payment shall be verified and certified by the Procuring Entity’s Representative/Project Engineer. Except as otherwise stipulated in the **SCC**, materials and equipment delivered on the site but not completely put in place shall not be included for payment.

15. Operating and Maintenance Manuals

- 15.1. If required, the Contractor will provide “as built” Drawings and/or operating and maintenance manuals as specified in the **SCC**.

- 15.2. If the Contractor does not provide the Drawings and/or manuals by the dates stated above, or they do not receive the Procuring Entity's Representative's approval, the Procuring Entity's Representative may withhold the amount stated in the **SCC** from payments due to the Contractor.

Section V. Special Conditions of Contract

Notes on the Special Conditions of Contract

Similar to the BDS, the clauses in this Section are intended to assist the Procuring Entity in providing contract-specific information in relation to corresponding clauses in the GCC found in Section IV.

The Special Conditions of Contract (SCC) complement the GCC, specifying contractual requirements linked to the special circumstances of the Procuring Entity, the Procuring Entity's country, the sector, and the Works procured. In preparing this Section, the following aspects should be checked:

- a. Information that complements provisions of the GCC must be incorporated.
- b. Amendments and/or supplements to provisions of the GCC as necessitated by the circumstances of the specific purchase, must also be incorporated.

However, no special condition which defeats or negates the general intent and purpose of the provisions of the GCC should be incorporated herein.

Special Conditions of Contract

GCC Clause	
2	Completion of work shall be within 150 calendar days.
4.1	The Procuring Entity shall give possession of all parts of the Site to the Contractor upon receipt of the Notice to Proceed.
6	The site investigation reports are: <i>[list here the required site investigation reports.]</i>
7.2	<p><i>[Select one, delete the other.]</i></p> <p><i>[In case of permanent structures, such as buildings of types 4 and 5 as classified under the National Building Code of the Philippines and other structures made of steel, iron, or concrete which comply with relevant structural codes (e.g., DPWH Standard Specifications), such as, but not limited to, steel/concrete bridges, flyovers, aircraft movement areas, ports, dams, tunnels, filtration and treatment plants, sewerage systems, power plants, transmission and communication towers, railway system, and other similar permanent structures:]</i> Fifteen (15) years.</p> <p><i>[In case of semi-permanent structures, such as buildings of types 1, 2, and 3 as classified under the National Building Code of the Philippines, concrete/asphalt roads, concrete river control, drainage, irrigation lined canals, river landing, deep wells, rock causeway, pedestrian overpass, and other similar semi-permanent structures:]</i> Five (5) years.</p> <p><i>[In case of other structures, such as bailey and wooden bridges, shallow wells, spring developments, and other similar structures:]</i> Two (2) years.</p>
10	Dayworks are applicable at the rate shown in the Contractor's original Bid.
13	The amount of the advance payment is no more that fifteen percent (15%) of the Contract Price subject to approval by the HOPE and compliance with the conditions under RA 9184 and its IRR.
14	No further instructions.
15.1	<p>The date by which operating and maintenance manuals are required is <i>thirty (30) days</i></p> <p>The date by which "as built" drawings are required as part of final payment</p>
15.2	The amount to be withheld for failing to produce "as built" drawings and/or operating and maintenance manuals by the date required is ten (10%) percent of the contract price.

Section VI. Specifications

Notes on Specifications

A set of precise and clear specifications is a prerequisite for Bidders to respond realistically and competitively to the requirements of the Procuring Entity without qualifying or conditioning their Bids. In the context of international competitive bidding, the specifications must be drafted to permit the widest possible competition and, at the same time, present a clear statement of the required standards of workmanship, materials, and performance of the goods and services to be procured. Only if this is done will the objectives of economy, efficiency, and fairness in procurement be realized, responsiveness of Bids be ensured, and the subsequent task of bid evaluation facilitated. The specifications should require that all goods and materials to be incorporated in the Works be new, unused, of the most recent or current models, and incorporate all recent improvements in design and materials unless provided otherwise in the Contract.

Samples of specifications from previous similar projects are useful in this respect. The use of metric units is mandatory. Most specifications are normally written specially by the Procuring Entity or its representative to suit the Works at hand. There is no standard set of Specifications for universal application in all sectors in all regions, but there are established principles and practices, which are reflected in these PBDs.

There are considerable advantages in standardizing General Specifications for repetitive Works in recognized public sectors, such as highways, ports, railways, urban housing, irrigation, and water supply, in the same country or region where similar conditions prevail. The General Specifications should cover all classes of workmanship, materials, and equipment commonly involved in construction, although not necessarily to be used in a particular Works Contract. Deletions or addenda should then adapt the General Specifications to the particular Works.

Care must be taken in drafting specifications to ensure that they are not restrictive. In the specification of standards for goods, materials, and workmanship, recognized international standards should be used as much as possible. Where other particular standards are used, whether national standards or other standards, the specifications should state that goods, materials, and workmanship that meet other authoritative standards, and which ensure substantially equal or higher quality than the standards mentioned, will also be acceptable. The following clause may be inserted in the SCC.

Sample Clause: Equivalency of Standards and Codes

Wherever reference is made in the Contract to specific standards and codes to be met by the goods and materials to be furnished, and work performed or tested, the provisions of the latest current edition or revision of the relevant standards and codes in effect shall apply, unless otherwise expressly stated in the Contract. Where such standards and codes are national, or relate to a particular country or region, other authoritative standards that ensure a substantially equal or higher quality than the standards and codes specified will be accepted

subject to the Procuring Entity's Representative's prior review and written consent. Differences between the standards specified and the proposed alternative standards shall be fully described in writing by the Contractor and submitted to the Procuring Entity's Representative at least twenty-eight (28) days prior to the date when the Contractor desires the Procuring Entity's Representative's consent. In the event the Procuring Entity's Representative determines that such proposed deviations do not ensure substantially equal or higher quality, the Contractor shall comply with the standards specified in the documents.

These notes are intended only as information for the Procuring Entity or the person drafting the Bidding Documents. They should not be included in the final Bidding Documents.



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PROJECT TITLE : PROPOSED REHABILITATION OF ELECTRICAL SYSTEM AT JUDGE FELICIANO BELMONTE SR. HIGH SCHOOL

LOCATION : BARANGAY HOLY SPIRIT, DISTRICT 2, QUEZON CITY

TECHNICAL SPECIFICATIONS

I. GENERAL REQUIREMENTS

- A. Comply with the current and existing laws, ordinances and applicable codes, rules and regulations, and standards. Any works performed contrary to the existing laws, rules and regulations, ordinances and standards without notice shall bear all cost arising therefrom.
- B. Drawings, specifications, codes and standards are minimum requirements. Where requirements differ, the more stringent apply.
- C. Should there be any change(s) in drawings or specifications, it is required to comply with the governing regulations, notify the implementing agency.
- D. Photographs shall be taken as, when and where directed at intervals of not more than one month. The photographs shall be sufficient in number and location, to record the exact progress of the works. The photographs shall be retained and will become the property of the Government.
- E. Site verification / inspection shall be conducted to validate the scope of works. No extra compensation and extension of time shall be given due to negligence or inadvertence.
- F. The quality of materials shall be of the best grade of their respective kinds for the purpose. The work shall also be performed in the best and most capable manner in strict accordance with requirements of the plans and details. All materials not conforming to the requirements of these specifications shall be considered as defective.
- G. All equipment and installations shall meet or exceed minimum requirements of the standards and codes
- H. Mobilization and Demobilization (if applicable)
 1. Mobilization shall include all activities and related costs for transportation of personnel, equipment, and operating supplies to the site; establishment of offices, buildings, and other necessary general facilities for the operations at the site.
 2. Demobilization shall include all activities and costs for transportation of personnel, equipment, and supplies not anymore required within the construction site including the disassembly, removal and site clean-up of offices and other facilities assembled on the site specifically for this contract.
- I. Execute work in strict accordance with the best practices of the trades in a thorough, substantial, workmanlike manner by competent workmen. Provide a competent, experienced, full-time supervisor who is authorized to make decisions on behalf of the Contractor.
- J. Temporary Facilities and Utilities
 1. All facilities shall be near the job site, where necessary and shall conform to the best standard for the required types
 2. Temporary facilities shall be provided and maintained including sanitary facilities and first aid stations.

3. Temporary utilities shall be sufficiently provided until the completion of the project such as water, power and communication.
 4. Temporary enclosure shall be provided around the construction site with adequate guard lights, railings and proper signage
 5. Temporary roadways shall be constructed and maintained to sustain loads to be carried on them during the entire construction period.
 6. Upon completion of the work, the temporary facilities shall be demolished, hauled-out and disposed properly.
- K. Adequate construction safety and health protection shall be provided at all times during the execution of work to both workers and property.
1. A fully-trained Medical Aide shall be employed permanently on the site who shall be engaged solely to medical duties.
 2. The medical room shall be provided with waterproofing; it could be a building or room designated and used exclusively for the purpose and have a floor area of at least 15 square meters and a glazed window area of at least 2 square meters.
 3. The location of the medical room and any other arrangements shall be made known to all employees by posting on prominent locations and suitable notices in the site.
 4. Additional safety precautions shall be provided in the event of a pandemic. Protocols set forth by the government shall be strictly followed
 5. Construction safety shall consist of construction canopy and safety net.
- L. Necessary protections to the adjacent property shall be provided to avoid untoward incidents / accidents.
- M. Final cleaning of the work shall be employed prior to the final inspection for the certification of final acceptance. Final cleaning shall be applied on each surface or unit of work and shall be of condition expected for a building cleaning and maintenance program.

II. CIVIL / STRUCTURAL WORKS

A. MASONRY WORKS

1. Masonry Units (Concrete Hollow Blocks):
 - a. 100mm thick for all interior walls and 150mm thick for all exterior walls unless otherwise indicated.
 - b. Use 400 psi for non-load bearing blocks and 700 psi for load bearing blocks where required.
 - c. Where full height walls are constructed with concrete hollow blocks, these shall extend up to the bottom of beam or slab unless otherwise indicated on plans. Provide stiffener columns and lintel beams as specified in the structural drawings or as specified or as deemed required to assure a stabilized wall due to height and other considerations.
2. Sand:

S-1, washed, clean and greenish in color.
3. Mortar:

One part Portland cement and two parts sand and water but not more than three parts sand and water.

III. ARCHITECTURAL WORKS

ROOFING WORKS

1. Corrugated galvanized iron (G.I.) sheets, including plain aluminum sheets for roofing accessories shall be cold-rolled meeting ASTM A-153 and with spelter coating of zinc of not less than 0.381 kg/sq.m. (1.25 ounce/sq.ft.) conforming to ASTM A-525 or pns 67:1985. Unless otherwise specified or shown on Plans, roofing sheets shall be gauge 26 (0.48mm thick) and provided in long span sizes to minimize end laps. Sheets shall weigh not less than 3.74 kg/sq.m. and shall be marked or stamped showing the gauge, size amount of zinc coating, brand and name of manufacturer. Test specimens shall stand being bent through 180 degrees flat on itself without fracture of the base metal and without flaking of the zinc coating.
2. Ridge/hip rolls, valleys, flashing and counter flashings, gutters and downspouts, whenever required, shall be fabricated from plain G.I. sheets. Ridge/hip rolls, flashings and counter flashings shall be gauge 26. Valleys, gutters and downspouts shall be gauge 24 unless otherwise specified on Plans. Wire basket strainers shall be galvanized, gauge 24.

Roof ventilators, whenever required shall be fabricated from gauge 26 plain G.I. sheets and constructed to the dimensions and details shown on Plans.

3. The roofing shall be secured to the purlins with min. 2 1/4" max. 3" long Tek screws. Provide all-purpose sealant under the fasteners. Ridge rolls, hip rolls and valleys to be used shall be those compatible with the Ga. 24 pre-painted G.I. rib-type roofing sheets. They shall lap the roofing sheets at least 250mm. The ridge rolls, hip rolls and valleys shall be riveted to the roofing sheets.
4. Polycarbonate roofing and sunbreakers shall be covered with 6mm thick Rib-type polycarbonate sheets as shown on the plans. The roofing shall be secured to the purlins with min. 2 1/4" max. 3" long Tek screws. Provide all-purpose sealant under the fasteners. Ridge rolls, hip rolls and valleys to be used shall be those compatible with the 6mm thick solid polycarbonate sheets. They shall lap the roofing sheets at least 250mm. The ridge rolls, hip rolls and valleys shall be riveted to the roofing sheets.
5. All roofing sheets adjacent to concrete hollow block and other masonry walls such as property line firewalls, shall be provided with Gauge 26 pre-painted plain G.I. Flashing to extend to the top and over to the other side of the wall. All fasteners shall be placed at the top of the corrugations of the roofing sheets to prevent water from standing around the fasteners.
6. Provide 6mm thick thermal insulation with single-side aluminum foil prior to fastening of roofing sheets to serve as thermal protection.

CEILING FINISHES

Fiber Cement Board on Metal Frame. The ceiling materials to be used shall conform to the samples approved by the City Engineer. All ceiling works shall be done by men experienced and qualified to do this particular specialty trade. The installation of ceiling materials shall be in accordance with the detailed section and with the manufacturer's manual instructions. Ceiling materials shall be cut as required to fit the perpendicular condition and should be properly secured by anchorage and other accessories to

PAINTING WORKS

1. Paint Materials. All types of paint material and other related products shall be subject to test as to material composition by the Bureau of Research and Standard, DPWH or the National Institute of Science and Technology.
2. Tinting Colors. Tinting colors shall be first grade quality pigment ground in alkylid resin that disperses and mixes easily with paint to produce the color desired. Use the same brand of paint and tinting color to effect good paint body.

3. Skim coat. Skim coat shall be fine powder type material like kalsomine that can be mixed into putty consistency, with oil-based primers and paints to fill minor surface dents and imperfections.

4. Paint Schedule.

- a. Interior Masonry Wall (plain cement plastered finish to be painted)

- i. 1 coat skim coating, 1 coat primer, 2 coats latex paint finish

- b. Ceiling Boards

- i. 1 coat primer, 2 coats latex paint finish

5. Surface Preparation. All surfaces shall be in proper condition to receive the finish. Woodworks shall be hand-sanded smooth and dusted clean. All knot-holes pitch pockets or seamy portions shall be sealed with natural wood filler. Nail holes, cracks or defects shall be carefully puttied after the first coat matching the color of paint.

Interior woodworks shall be sandpapered between coats. Cracks, holes or imperfections in plaster shall be filled with patching compound and smoothed off to match adjoining surfaces.

Concrete and masonry surfaces shall be coated with concrete neutralizer and allowed to dry before any painting primer coat is applied. When surface is dried apply first coating. Hairline cracks and unevenness shall be patched and sealed with approved putty or patching compound. After all defects are corrected apply the finish coats as specified on the Plans (color scheme approved)

Metal shall be clean, dry and free from mill scale and rust. Remove all grease and oil from surfaces. Wash unprimed galvanized metal with etching solution and allow it to dry. Where required to prime coat surface with Red Lead Primer same shall be approved by the Engineer

In addition, the Contractor shall undertake the following:

- a. Voids, cracks, nick etc. will be repaired with proper patching material and finished flush with surrounding surfaces.
 - b. Marred or damaged shop coats on metal shall be spot primed with appropriate metal primer.
 - c. Painting and varnishing works shall not be commenced when it is too hot or cold.
 - d. Allow appropriate ventilation during application and drying period
 - e. All hardware will be filled and removed or protected prior to painting and varnishing works.
6. Application. Paints when applied by brush shall become non-fluid, thick enough to lay down an adequate film of wet paint. Brush marks shall have flowed out after application of paint.

Paints made for application by roller must be similar to brushing paint. It must be non-sticky when thinned to spraying viscosity so that it will break up easily into droplets.

Paint is atomized by high pressure pumping rather than broken up by the large volume of air mixed with it. This procedure changes the required properties of the paint.

7. Application shall be as per paint Manufacturer's specification and recommendation.
8. Provide all drop cloth and other covering requisite for protection of floors, walls, aluminum, glass finishes and other works.
9. All applications and methods used shall strictly follow the Manufacturer's Instructions and Specifications.

10. All surfaces including masonry wall shall be thoroughly cleaned, puttied, sandpapered, rubbed and polished; masonry wall shall be treated with Neutralizer.
11. All exposed finish hardware, lighting fixtures and accessories, glass and the like shall be adequately protected so that these are not stained with paint and other painting materials prior to painting works.
12. All other surfaces endangered by stains and paint marks should be taped and covered with craft paper.

IV. ELECTRICAL WORKS

A. CONDUITS, BOXES AND FITTINGS

1. This item shall consist of the furnishing and installation of the complete conduit work, consisting of electrical conduits; conduit boxes such as junction boxes, pull boxes, utility boxes, octagonal and square boxes; conduit fittings, such as couplings, locknuts and bushings and other electrical materials needed to complete the conduit roughing-in work of this project.
2. All materials shall be brand new and shall be of the approved type meeting all the requirements of the Philippine Electrical Code and bearing the Philippine Standard Agency (PSA) mark.
3. All works throughout shall be executed in the best practice in a workmanlike manner by qualified and experienced electricians under the immediate supervision of a duly licensed Electrical Engineer.
4. The work to be done under this division of specifications consists of the fabrication, furnishing, delivery and installation, complete in all details of the electrical work, at the subject premises and all work materials incidental to the proper completion of the installation, except those portions of the work which are expressly stated to be done by other fields. All works shall be done in accordance with the rules and regulations and with the specifications.
5. All lighting fixtures and lamps are as specified and listed on lighting fixture schedule.
6. All grounding system installation shall be executed in accordance with the approved plans. Grounding system shall include building perimeter ground wires, ground rods, clamps, connectors, ground wells and ground wire taps as shown in the approved design.
7. All auxiliary systems such as telephone and intercom system, time clock system, fire alarm system and public address/nurse's call/paging system installations shall be done in accordance with the approved design.
8. Upon completion of the electrical construction work, the contractor shall provide all test equipment and personnel and to submit written copies of all test results.
9. The contractor shall guarantee the electrical installation are done and in accordance with the approved plans and specifications. The contractor shall guarantee that the electrical systems are free from all grounds and from all defective workmanship and materials and will remain so for a period of one year from date and acceptance of works. Any defect shall be remedied by the Contractor at his own expense.

B. WIRES AND WIRING DEVICES

1. This item shall consist of the furnishing and installation of all wires and wiring devices consisting of electric wires and cables, wall switches, convenience receptacles, heavy duty receptacles and other devices shown on the approved Plans but not mentioned in these specifications.
2. Wires and cables shall be of the approved type meeting all the requirements of the Philippine Electrical Code and bearing the Philippine Standard Agency (PSA) mark. Unless specified or indicated otherwise, all power and lighting conductors shall be

insulated for 600 volts. All wires shall be copper, soft drawn and annealed, smooth and of cylindrical form and shall be centrally located inside the insulation.

3. Conductors or wires shall not be drawn in conduits until after the cement plaster is dry and the conduits are thoroughly cleaned and free from dirt and moisture. In drawing wires into conduits, sufficient slack shall be allowed to permit easy connections for fixtures, switches, receptacles and other wiring devices without the use of additional splices.
 4. All conductors of convenience outlets and lighting branch circuit homeruns shall be wired with a minimum of 3.5 mm in size. Circuit homeruns to panelboards shall not be smaller than 3.5 mm but all homeruns to panelboard more than 30 meters shall not be smaller than 5.5 mm. No conductor shall be less than 2 mm in size.
 5. All wires of 14mm and larger in size shall be connected to panels and apparatus by means of approved type lugs or connectors of the solderless type, sufficiently large enough to enclose all strands of the conductors and securely fastened. They shall not loosen under vibration or normal strain.
 6. All joints, taps and splices on wires larger than 14 mm shall be made of suitable solderless connectors of the approved type and size. They shall be taped with rubber and PVC tapes providing insulation not less than that of the conductors.
 7. No splices or joints shall be permitted in either feeder or branch conductors except within outlet boxes or accessible junction boxes or pull boxes. All joints in branch circuit wiring shall be made mechanically and electrically secured by approved splicing devices and taped with rubber and PVC tapes in a manner which will make their insulation as that of the conductor.
 8. All wall switches and receptacles shall be fitted with standard Bakelite face plate covers. Device plates for flush mounting shall be installed with all four edges in continuous contact with finished wall surfaces without the use of coiled wire or similar devices. Plaster filling shall not be permitted. Plates installed in wet locations shall be gasketed.
 9. When more than one switch or device is indicated in a single location, gang plate shall be used.
- C. Comply with the current applicable codes, ordinances, and regulations of the authority or authorities having jurisdiction, the rules, regulations and requirements of the utility companies (as applicable).
- D. Drawings, specifications, codes and standards are minimum requirements. Where requirements differ, the more stringent apply.
- E. All equipment and installations shall meet or exceed minimum requirements of the Standards and Codes.
- F. Execute work in strict accordance with the best practices of the trades in a thorough, substantial, workmanlike manner by competent workmen.
- G. When the tests and inspections have been completed, a label shall be attached to all devices tested. The label shall provide the name of the testing company, the date the tests were completed, and the initials of the person who performed the tests.

H. PANELBOARDS

1. Fabricate and test panelboards according to IEEE 344 to withstand seismic forces defined in Division 16 Sections 16073 and 16074 "Hangers and Supports for Electrical Systems and Vibration and Seismic controls for Electrical Systems" respectively.
2. Enclosures: Flush, Surface, Flush- and surface-mounted cabinets.
 - a. Rated for environmental conditions at installed location.
 - i. Indoor Dry and Clean Locations: NEMA, Type 1.

- ii. Outdoor Locations: NEMA Type 3R.
 - iii. Kitchen and Wash-Down Areas: NEMA, Type 4X, stainless steel.
 - iv. Indoor Locations Subject to Dust, Falling Dirt, and Dripping Noncorrosive Liquids: NEMA, Type 12.
 - v. Outdoor Locations Subject to Dust, Falling Dirt and Dripping Noncorrosive Liquids: NEMA, Type 5R.
- b. Front: Secured to box with concealed trim clamps. For surface-mounted fronts, match box dimensions; for flush-mounted fronts, overlap box.
 - c. Hinged Front Cover: Entire front trim hinged to box and with standard door within hinged trim cover.
 - d. Skirt for Surface-Mounted Panelboards: Same gauge and finish as panelboard front with flanges for attachment to panelboard, wall, and ceiling or floor.
 - e. Gutter Extension and Barrier: Same gauge and finish as panelboard enclosure; integral with enclosure body. Arrange to isolate individual panel sections.
 - f. Finishes
 - i. Panels and Trim: Steel and galvanized steel, factory finished immediately after cleaning and pretreating with manufacturer's standard two-coat, baked-on finish consisting of prime coat and thermosetting topcoat.
 - ii. Back Boxes: Galvanized steel. Same finish as panels and trim.
 - iii. Fungus Proofing: Permanent fungicidal treatment for overcurrent protective devices and other components.
 - g. Directory Card: Inside panelboard door, mounted in transparent card holder metal frame with transparent protective cover.
3. Incoming Mains Location: Top or Bottom.
4. Phase, Neutral, and Ground Buses:
- a. Material: Hard-drawn copper, 98 percent conductivity.
 - b. Equipment Ground Bus: Adequate for feeder and branch-circuit equipment grounding conductors, bonded to box.
 - c. Neutral Bus: 100 percent of phase bus. Extra-Capacity Neutral Bus: Neutral bus rated 200 percent of phase bus and UL listed as suitable for nonlinear loads.
1. parts of the structure and equipment damaged by the Contractor in the prosecution of the work shall be replaced as shown on the Plans.
- A. Comply with the current applicable codes, ordinances, and regulations of the authority or authorities having jurisdiction, the rules, regulations and requirements of the utility companies (as applicable).
- B. Drawings, specifications, codes and standards are minimum requirements. Where requirements differ, the more stringent apply.


 ENGR. KELVIN M. MARZONÍA
 E.E., Planning and Design Division


 ENGR. RALPH GREGOR M. MANALO
 C.E., Planning and Design Division

Section VII. Drawings

[Insert here a list of Drawings. The actual Drawings, including site plans, should be attached to this section, or annexed in a separate folder.]

THE SITE



THE SITE



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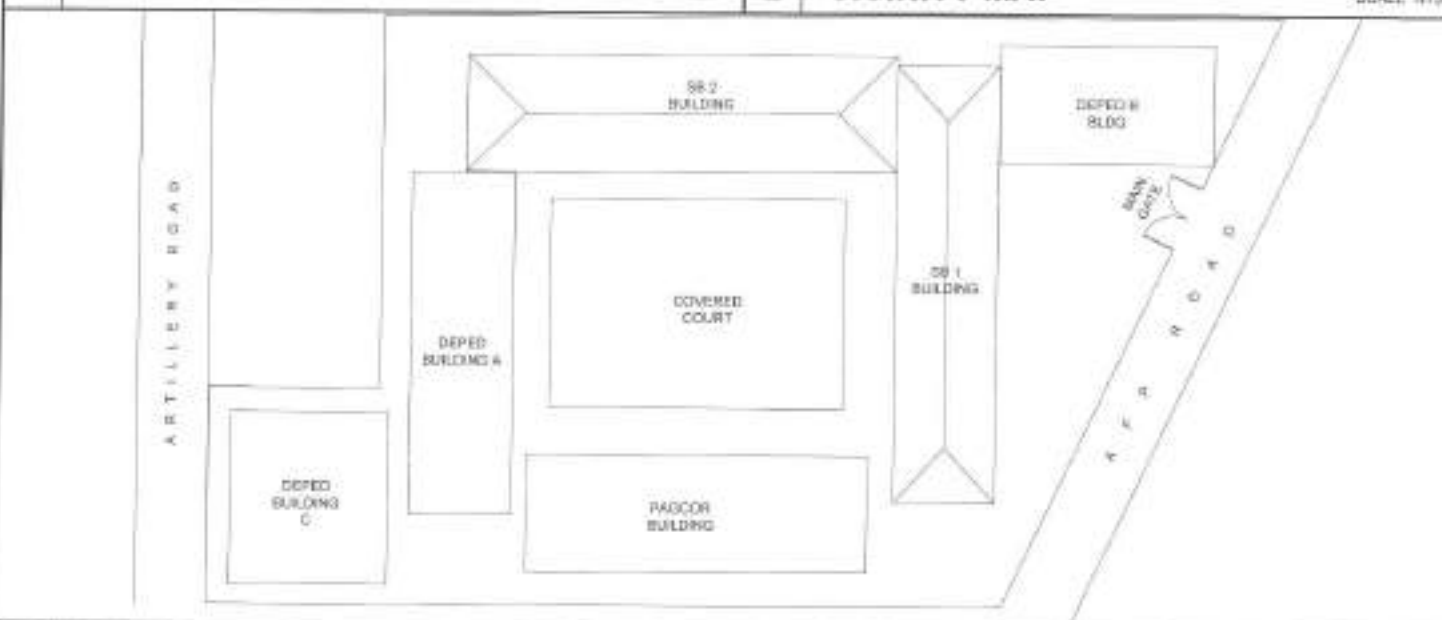
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	LOCATION PLAN		LIGHTING LAYOUT SB-2 BUILDING
	SITE DEVELOPMENT PLAN		3RD FLOOR PLAN
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AR-3	REFLECTED CEILING PLAN SB-1		2ND AND 4TH FLOOR PLAN
	BLDG 4TH FLR	EL-18	POWER LAYOUT PASGOR BUILDING
	REFLECTED CEILING PLAN DEPED		GROUND FLOOR PLAN
	C 4TH FLR		POWER LAYOUT PASGOR BUILDING
AR-4	REFLECTED CEILING PLAN PASGOR		2ND TO 4TH FLOOR PLAN
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	REFLECTED CEILING PLAN DEPED A		GROUND FLOOR PLAN
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EL-4	LOAD SCHEDULE		WALL FAN LAYOUT DEPED C BUILDING
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	GROUND FLOOR PLAN		GROUND FLOOR PLAN
	LIGHTING LAYOUT DEPED C BUILDING		WALL FAN LAYOUT SB-1 BUILDING
	2ND TO 4TH FLOOR PLAN		3RD FLOOR PLAN
EL-7	LIGHTING LAYOUT SB-1 BUILDING	EL-25	WALL FAN LAYOUT SB-1 BUILDING
	GROUND FLOOR PLAN		2ND AND 4TH FLOOR PLAN
	LIGHTING LAYOUT SB-1 BUILDING	EL-26	WALL FAN LAYOUT PASGOR BUILDING
	3RD FLOOR PLAN		GROUND FLOOR PLAN
EL-8	LIGHTING LAYOUT SB-1 BUILDING		WALL FAN LAYOUT PASGOR BUILDING
	2ND AND 4TH FLOOR PLAN		2ND TO 4TH FLOOR PLAN
EL-9	LIGHTING LAYOUT PASGOR BUILDING	EL-27	WALL FAN LAYOUT DEPED B BUILDING
	GROUND FLOOR PLAN		GROUND FLOOR PLAN
	LIGHTING LAYOUT PASGOR BUILDING	EL-28	WALL FAN LAYOUT DEPED B BUILDING
	2ND AND 4TH FLOOR PLAN		2ND TO 4TH FLOOR PLAN
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	2ND TO 4TH FLOOR PLAN		

1 LOCATION MAP

SCALE: NTS.

2 VICINITY MAP

SCALE: NTS.



3 SITE DEVELOPMENT PLAN

SCALE: NTS.



Republic of the Philippines
Department of Engineering
Office of the Engineer in Charge
Office of the Engineer in Charge
Office of the Engineer in Charge
Office of the Engineer in Charge

PROJECT TITLE:
**PROPOSED REHABILITATION OF
ELECTRICAL SYSTEM AT JUDGE
FELICIANO BELMONTE SR. HIGH
SCHOOL**

LOCATION:
BRGY. HOLY SPIRIT, DISTRICT 2, QUEZON CITY

DATE:

DESIGNED BY: JRM
CHECKED BY: JRM

REVISION NO.

SUBMITTED BY:

ENGR. FREDERICKA D. DE GUZMAN
REAL PLANNING CONSULTANT

RECOMMENDING APPROVAL:

ENGR. ROBERT L. BELTRAN
DEPARTMENT OF ENGINEERING

APPROVED BY:

HON. MA. JOSEFINA G. BELMONTE
CITY MANAGER

SHEET CONTENT:

LOCATION MAP
VICINITY MAP
SITE DEVELOPMENT
PLAN

SHEET NO.

AR-01
01/37

2	ROOFING LAYOUT SB-1 BUILDING
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DEPARTMENT OF ENGINEERING
 Civil Engineering License No. 00000000000000000000
 Manila, Philippines
 Issued on 00/00/00
 www.deped.gov.ph

PROPOSED REHABILITATION OF ELECTRICAL SYSTEM AT JUDGE FELICIANO BELMONTE SR. HIGH SCHOOL

RECEIVED BY: NAME

ORDERED BY: RUP


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Done

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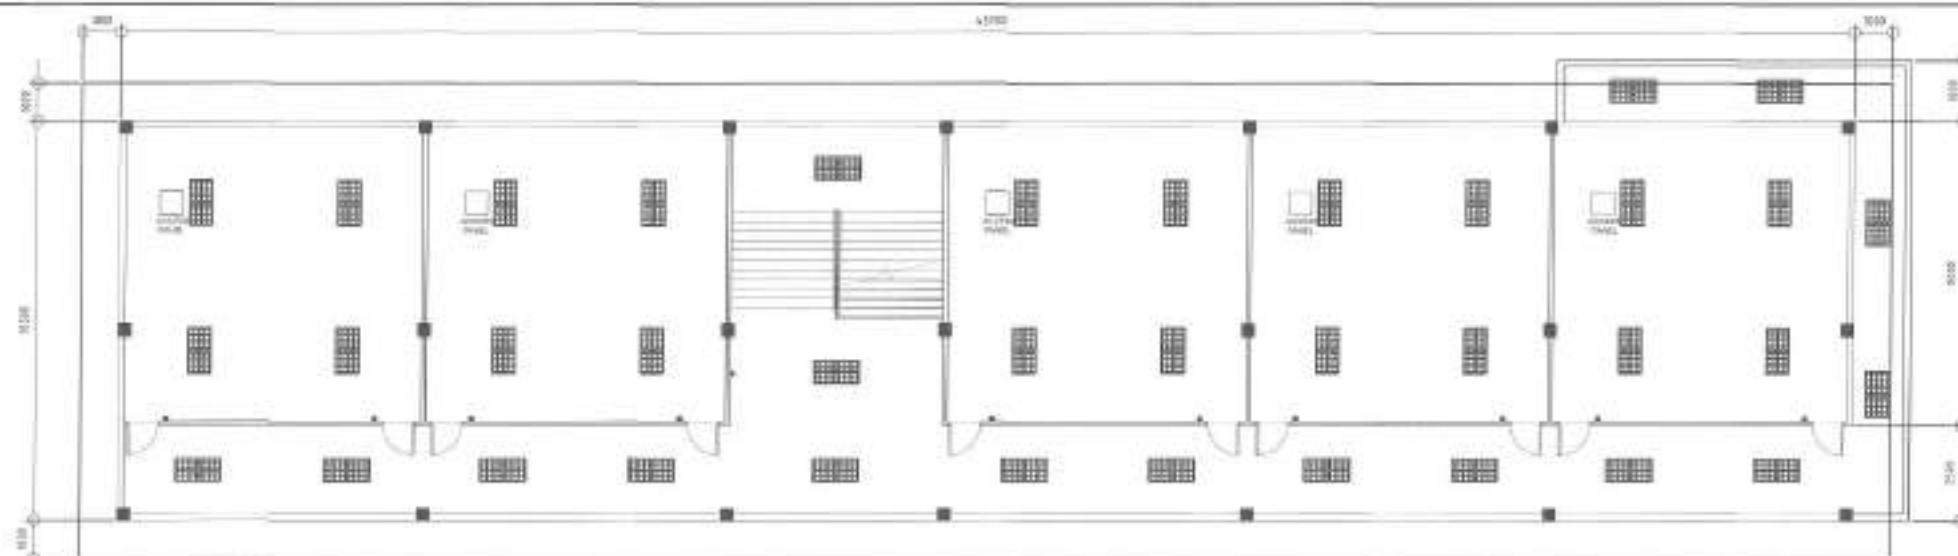
RECORDING LAYOUT
FBI - BUREAU

AR-02
02/27



1 REFLECTED CEILING PLAN DEPED C BUILDING 4TH FLOOR

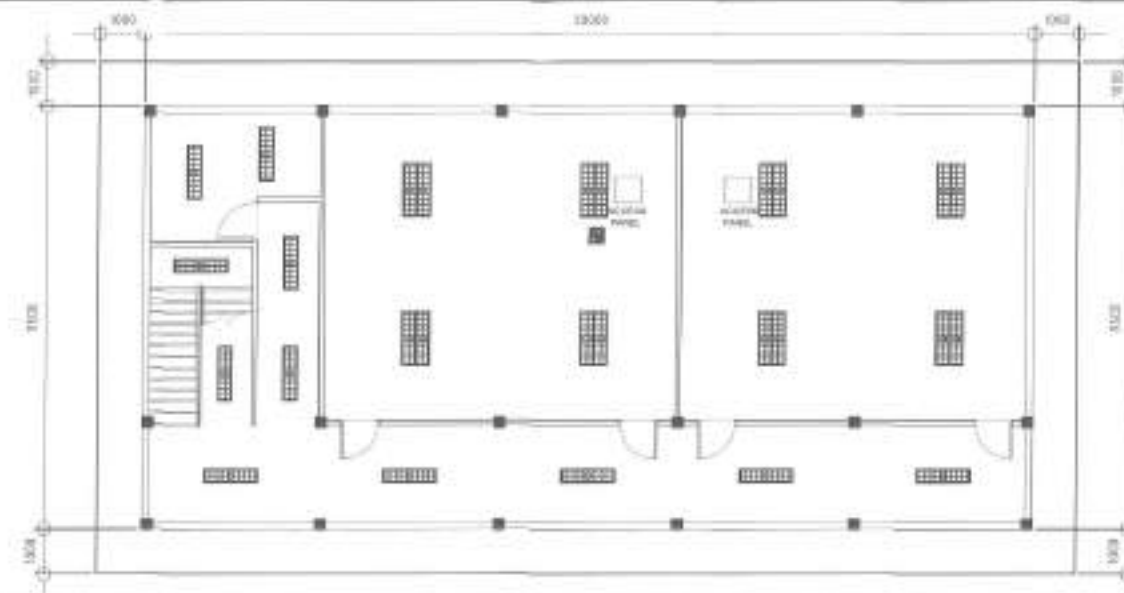SCALE 1:100M



2 REFLECTED CEILING PLAN SB-1 BUILDING 4TH FLOOR

SCALE 1:100M



Republic of the Philippines
Department of Engineering
1001, P.O. Box 1001, 1001, 1001
1001, 1001, 1001, 1001
1001, 1001, 1001, 1001

PROJECT TITLE:
**PROPOSED REHABILITATION OF
ELECTRICAL SYSTEM AT JUDGE
FELICIANO BELMONTE SR. HIGH
SCHOOL**

LOCATION:
BPO, HOLY SPIRIT, DISTRICT 2, CAGAYAN CITY

DATE:

DESIGNED BY: HMM

DRAWN BY: HMM

REVISION NO.:

SUBMITTED BY:

ENGR. FREDERICKA D. DE GUZMAN
HEAD, PLANNING & DESIGN DIVISION

RECOMMENDING APPROVAL:

ENGR. ROBERT L. BELTRAN
DEPARTMENT OF ENGINEERING

APPROVED BY:


HON. MA. JOSEFINA G. BELMONTE
CITY MAYOR

SHEET CONTENT

REFLECTED CEILING
PLAN SB-1 BLDG 4TH
FLOOR
REFLECTED CEILING
PLAN DEPED C 4TH
FLOOR


SHEET NO.

AR-03
03/37

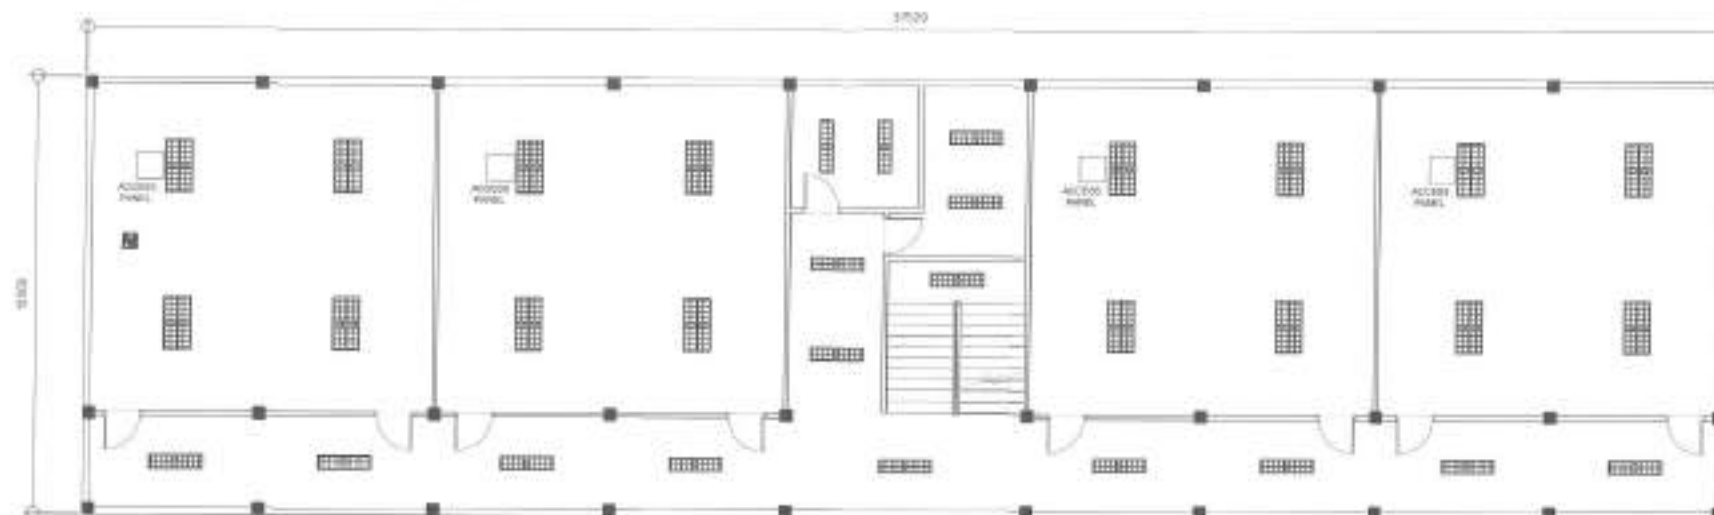

1 REFLECTED CEILING PLAN PAGCOR BUILDING 4TH FLOOR

SCALE 1:100M.

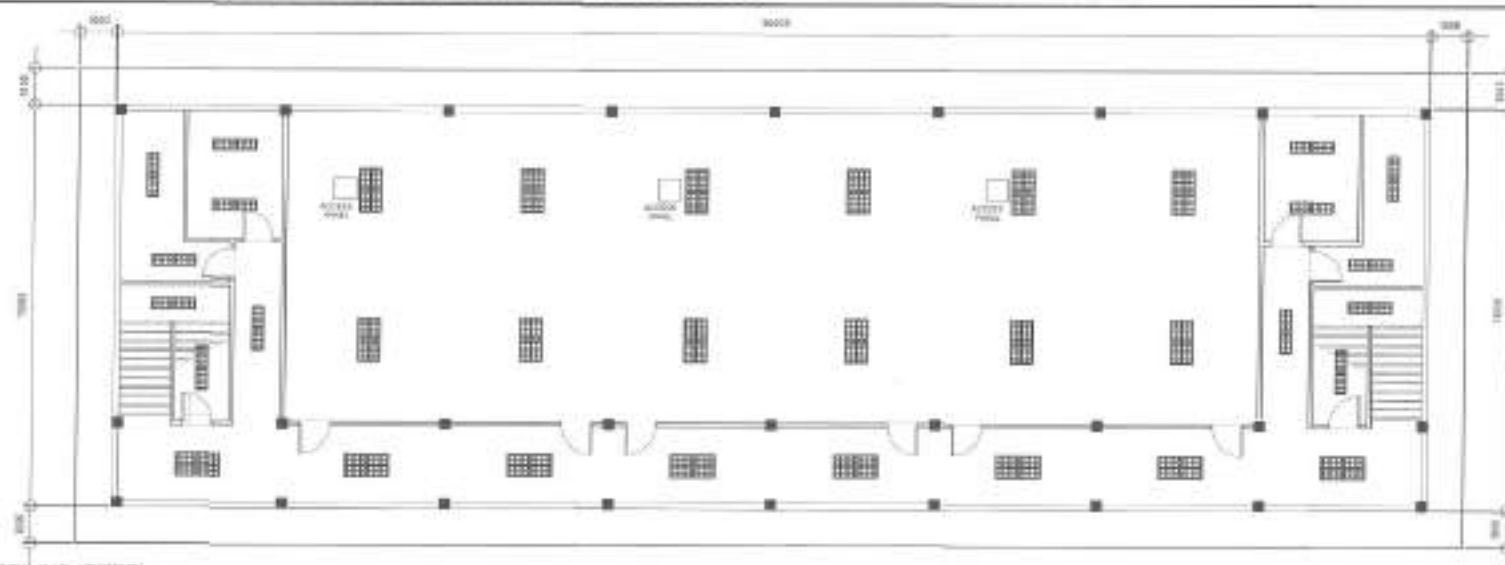

2 REFLECTED CEILING PLAN DEPED A BUILDING 4TH FLOOR

SCALE 1:100M.



Republic of the Philippines
Department of Engineering
San Carlos Building, 10th Floor, Department
General Services Office, Quezon City
Telephone: (02) 886-6661
Fax: (02) 886-6662

PROJECT TITLE:
**PROPOSED REHABILITATION OF
ELECTRICAL SYSTEM AT JUDGE
FELICIANO BELMONTE SR. HIGH
SCHOOL**

LOCATION:
BRGY. HOLY SPIRIT, DISTRICT 13, QUEZON CITY

DATE:

DESIGNED BY: JAM

CHECKED BY: JAM
APPROVED BY: JAM

REVISION NO.

SUBMITTED BY:

ENGR. FREDERICK D. DE GUZMAN
SEAL, PLUMBING & DESIGN OFFICE

RECOMMENDING APPROVAL:

ENGR. ROBERT L. BELTRAN
OIC, DEPARTMENT OF ENGINEERING

APPROVED BY:


HON. MA. JOSEFINA G. BELMONTE
CITY MAYOR

SHEET CONTENT:

REFLECTED CEILING
PLAN PAGCOR
BUILDING 4TH FLOOR
REFLECTED CEILING
PLAN DEPED A
BUILDING 4TH FLOOR

SHEET NO.

AR-04
04 37

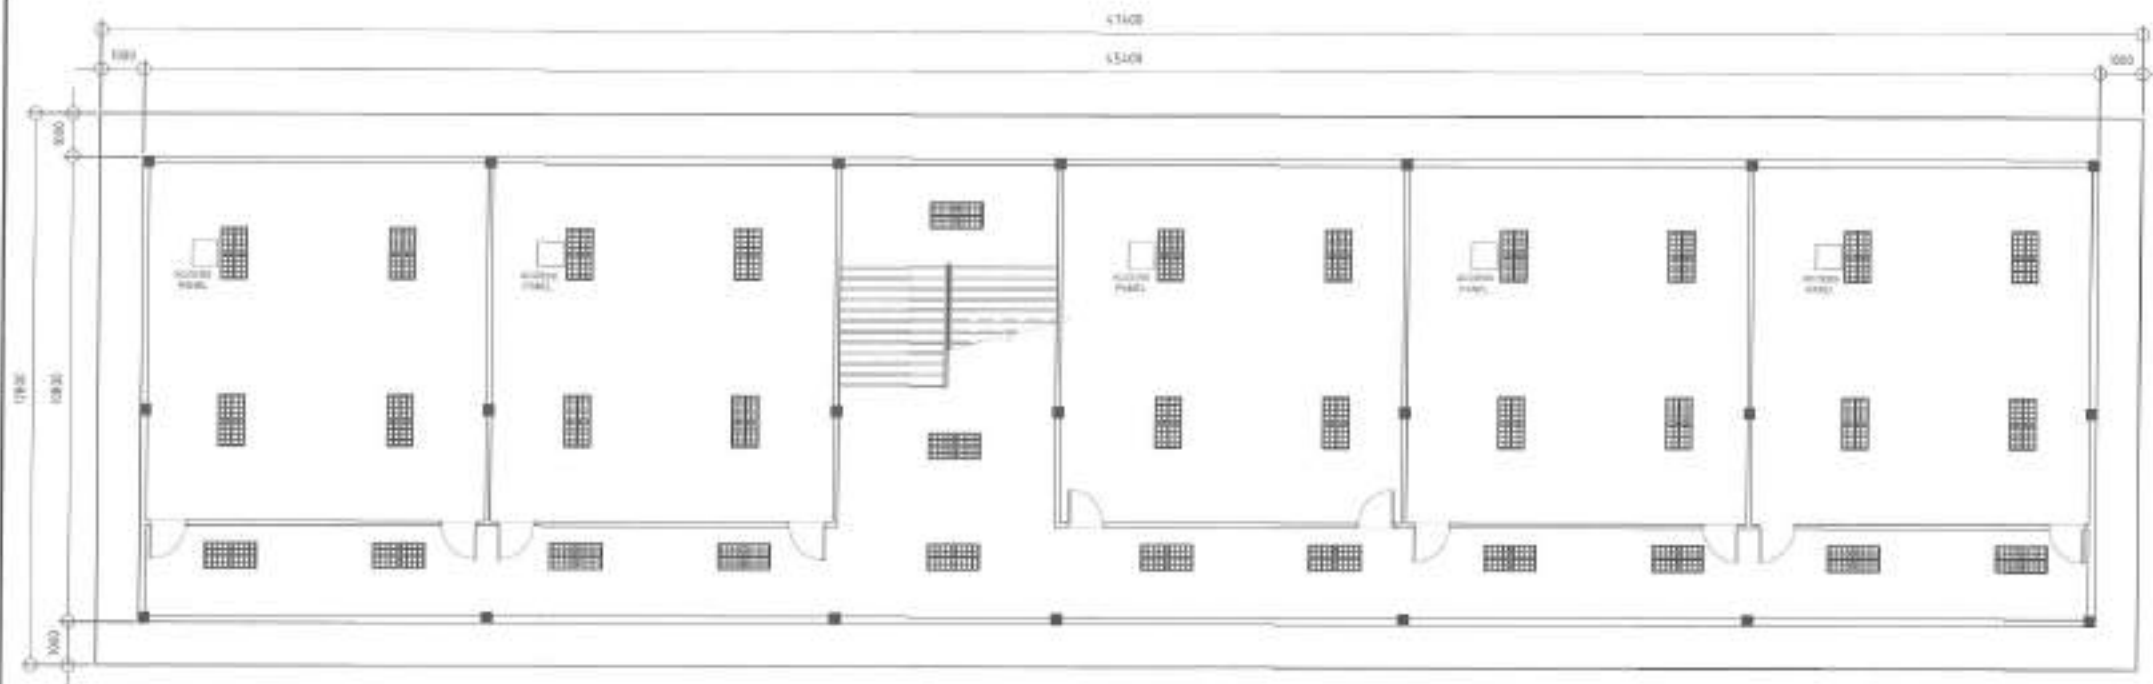


NOTE: REPLACEMENT OF CEILING (FIBER CEMENT BOARD) INCLUDING EAVES

2 REFLECTED CEILING PLAN SB-2 BUILDING 4TH FLOOR

SCALE 1:1000

 <p>Regulating Division Integrated as Division DEPARTMENT OF ENGINEERING JUN LUNA AUSTRIA, JUN 16, 2016, 10:00 AM, 10:00 AM 10:00 AM, 10:00 AM, 10:00 AM 10:00 AM, 10:00 AM, 10:00 AM</p>	PROJECT TITLE:	DATE:	SUBMITTER:	RECOMMENDING APPROVAL:	APPROVED BY:	SHEET CONTENT:	SHEET NO.
	PROPOSED REHABILITATION OF ELECTRICAL SYSTEM AT JUDGE FELICIANO BELMONTE SR. HIGH SCHOOL	DESIGNED BY: JMB  DRAWN BY: JMB  CHECKED BY: JMB 	 ENGR. FREDRICKA OL. DE GUZMAN HEAD, PLANNING & DESIGN DIVISION	 ENGR. ROBERT L. BELTRAN HEAD, PLANNING & DESIGN DIVISION	HON. RA. JOSEFINA G. BELMONTE CITY MAYOR	REFLECTED CEILING PLAN SB-2 BUILDING 4TH FLOOR	AR-05 05 37

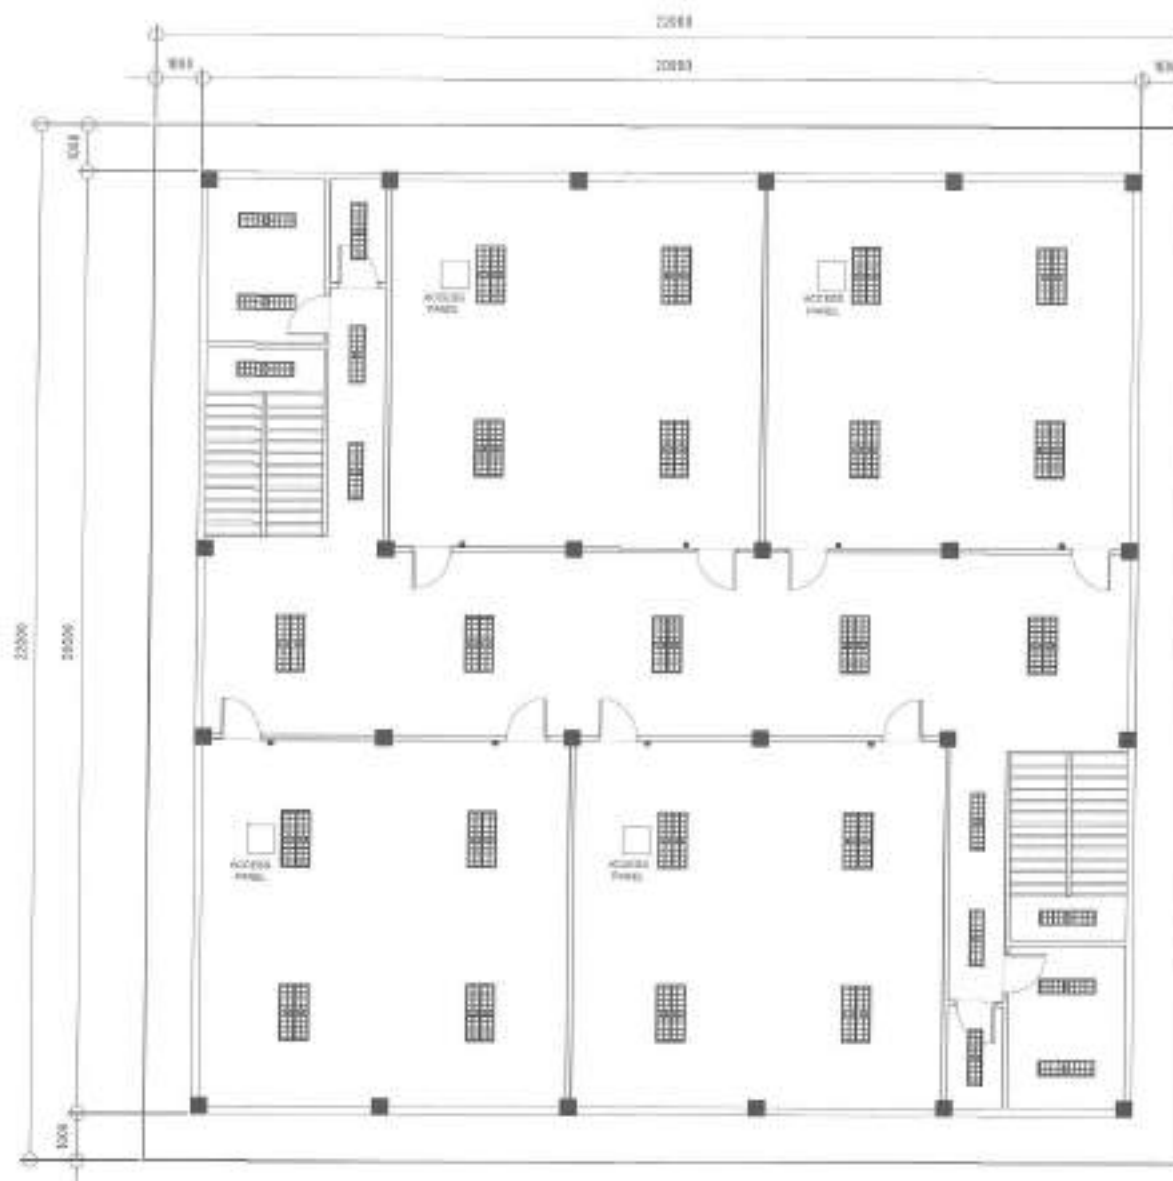

NOTE: REPLACEMENT OF CEILING (FIBER CEMENT BOARD) INCLUDING EAVES

1 REFLECTED CEILING PLAN DEPED B BUILDING 4TH FLOOR

SCALE 1:100M



Republic of the Philippines
 Department of Engineering
 Office of the City Engineer, City of Marikina
 Division Office, Marikina City
 Division Office, Marikina City

PROJECT TITLE:
**PROPOSED REHABILITATION OF
 ELECTRICAL SYSTEM AT JUDGE
 FELICIANO BELMONTE SR. HIGH
 SCHOOL**

LOCATION:
 BAY, HOLY SPIRIT, DISTRICT 8, CAGAYAN CITY

DATE:

DESIGNED BY: HBB

[Signature]

CHECKED BY: HBB

[Signature]

REVISION NO.:

SUBMITTED BY:

ENGR. FREDERICK O. DE GUZMAN
 HEAD, PLANNING & DESIGN DIV.

RECOMMENDED APPROVAL:

ENGR. ROBERT L. BELTRAN
 CH. REPAIRMENT OF ENGINEERING

APPROVED BY:

HON. MA. JOSEFINA G. BELMONTE
 CITY MAYOR

SHEET NO. 1 OF 1

REFLECTED CEILING
 PLAN DEPED B
 BUILDING 4TH FLOOR

AR-06
 06/37

GENERAL NOTES FOR THREE PHASE SYSTEM

- ALL WORKS SHALL BE EXECUTED IN ACCORDANCE TO THE LATEST EDITION OF THE PHILIPPINE ELECTRICAL CODE, PHILIPPINE ELECTRONICS CODE, THE NATIONAL BUILDING CODE OF THE PHILIPPINES AND OTHER RELATED LAWS AND ORDINANCES OF THIS CITY.
- ALL WORKS SHALL BE SUPERVISED BY A REGISTERED PROFESSIONAL RELATED TO THE ACTIVITIES BEING UNDERTAKEN.
- ALL WORKS SHALL BE COORDINATED WITH THE RESPECTIVE TRADES SO TO AVOID CONFLICTS DURING EXECUTION OF ACTIVITIES.
- ALL NECESSARY PERMITS SHALL BE SECURED AND TURNED OVER TO THE CITY.
- ALL DRAWINGS AND SPECIFICATIONS SHALL BE CORRECTLY REVIEWED BY THE CONTRACTOR AND SHALL IMMEDIATELY BE INFORMED IF DISCREPANCY (IES) FOUND HEREIN.
- ALL DIMENSIONS, ELEVATIONS AND REFERENCES SHALL BE VERIFIED WITH THE ACTUAL CONDITION PRIOR TO EXECUTION.
- SHOP DRAWINGS SHALL BE PROVIDED AS NECESSARY PRIOR TO THE EXECUTION.
- ALL WORKS SHALL BE TESTED AND COMMISSIONED AS INDICATED IN THE SPECIFICATIONS WITH THE PRESENCE OF ALL PARTIES INVOLVED; RESULTS SHALL BE DOCUMENTED PROPERLY.
- ALL PIPES AND LAYOUT ARE ONLY DIAGRAMMATIC; ACTUAL LAYOUT OF PIPES AND FITTINGS, UNLESS OTHERWISE REQUIRED, SHALL BE PROPERLY CONCEALED.
- NO PIPES SHALL BE ALLOWED TO BE EMBEDDED IN STRUCTURAL MEMBERS, UNLESS OTHERWISE APPROVED.
- ALL PIPES, FITTINGS, EQUIPMENT AND FIXTURES SHALL BE INSTALLED IN ACCORDANCE TO MANUFACTURERS SPECIFICATIONS AND INSTRUCTIONS.
- SUPPORTS AND HANGERS SHALL BE PROVIDED ACCORDINGLY.
- ALL EQUIPMENTS AND FIXTURES SHALL BE ENVIRONMENTAL FRIENDLY.
- INSTALLATION OF SERVICE ENTRANCE
 - THE TYPE OF SERVICE ENTRANCE SHALL BE THREE PHASE, THREE WIRE PLUS GROUND, 60 HERTZ, 250V AC NOMINAL.
 - THE SERVICE ENTRANCE EQUIPMENT SHALL BE PROPERLY GROUNDED IN ACCORDANCE WITH THE PHILIPPINE ELECTRICAL CODE.
 - THE MAIN OVERCURRENT PROTECTION DEVICE SHALL BE OF THERMAL MAGNETIC MCCB IN NEMA 3R WEATHERPROOF ENCLOSURE.
- PHASE A - RED
PHASE B - YELLOW
PHASE C - BLUE
NEUTRAL - WHITE
GROUND - GREEN
- ALL EMBEDDED BRANCH CIRCUITS SHALL BE PVC CONDUITS AND FOR EXPOSED INSTALLATION SHALL BE SAC SUPPORTED BY CONDUIT CLAMPS EVERY 700 MILLIMETERS AND/OR CONDUIT HANGER SUPPORTS EVERY 1500 MILLIMETERS.
- CONDUITS IN NO CASE SHALL NOT BE MORE THAN THE EQUIVALENT OF FOUR QUARTER BENDS IN ANY ONE RUN. ALL CONDUIT BENDS SHALL BE FIELD MADE BY USING HYDRAULIC BENDERS. MINIMUM BENDING RADIUS MUST BE IN ACCORDANCE TO THE CODE REQUIREMENTS.

15.7. THE GROUND RESISTANCE SHALL NOT BE MORE THAN 5 OHMS.

15.8. PULL BOXES SHALL BE WHENEVER NECESSARY TO FACILITATE WIRE PULLING EVEN IF THESE ARE NOT INDICATED ON PLANS.

15.9. FOR EACH SPARE BRANCH CIRCUIT IN PANELBOARD, PROVIDE ONE 20MM DIAMETER EMPTY CONDUIT TERMINATED TO 100MM OCTAGONAL BOX ABOVE CEILING. MINIMUM SIZE OF PULL BOX SHALL BE 150MM X 150MM X 100MM.

15.10. ALL CIRCUIT BREAKERS SHALL BE BOLT-ON TYPE WITH INTERRUPTING CAPACITY AS INDICATED IN THE PLANS. PANELBOARDS SHALL BE GALVANIZED SHEET POWDER COATED GAGE 18 MINIMUM.


15.11. FEEDER AND BRANCH CIRCUIT CONDUCTORS IN CABLE TRAYS SHALL BE GROUPED, BONDED AND TAGGED TO INDICATE CLEARLY THE ELECTRICAL CHARACTERISTICS SUCH AS CIRCUIT NUMBER AND PANEL DESIGNATION.

15.12. ALL MATERIALS TO BE USED AND THE EQUIPMENT TO BE INSTALLED SHALL BE OF THE BEST QUALITY, BRAND NEW AS SPECIFIED. IT MUST BE APPROVED TYPE FOR THE PARTICULAR LOCATION AND PURPOSE INTENDED.

SWITCH SINGLE GANG SWITCH FLOOD LIGHT BALL FAN 300mm x 1200mm TROFFER LIGHT, SURFACE MOUNTED 600mm x 900mm TROFFER LIGHT, SURFACE MOUNTED HIGH BAY LIGHTING INDUSTRIAL FAN	CONVENIENCE OUTLET ENCLOSURE CIRCUIT BREAKER PANEL BOARD CIRCUIT BREAKER 3 PHASE SECONDARY RACK CAPPING POST THREE WIRE FEEDER
---	--

2 LEGENDS AND SYMBOLS

SCALE NTS

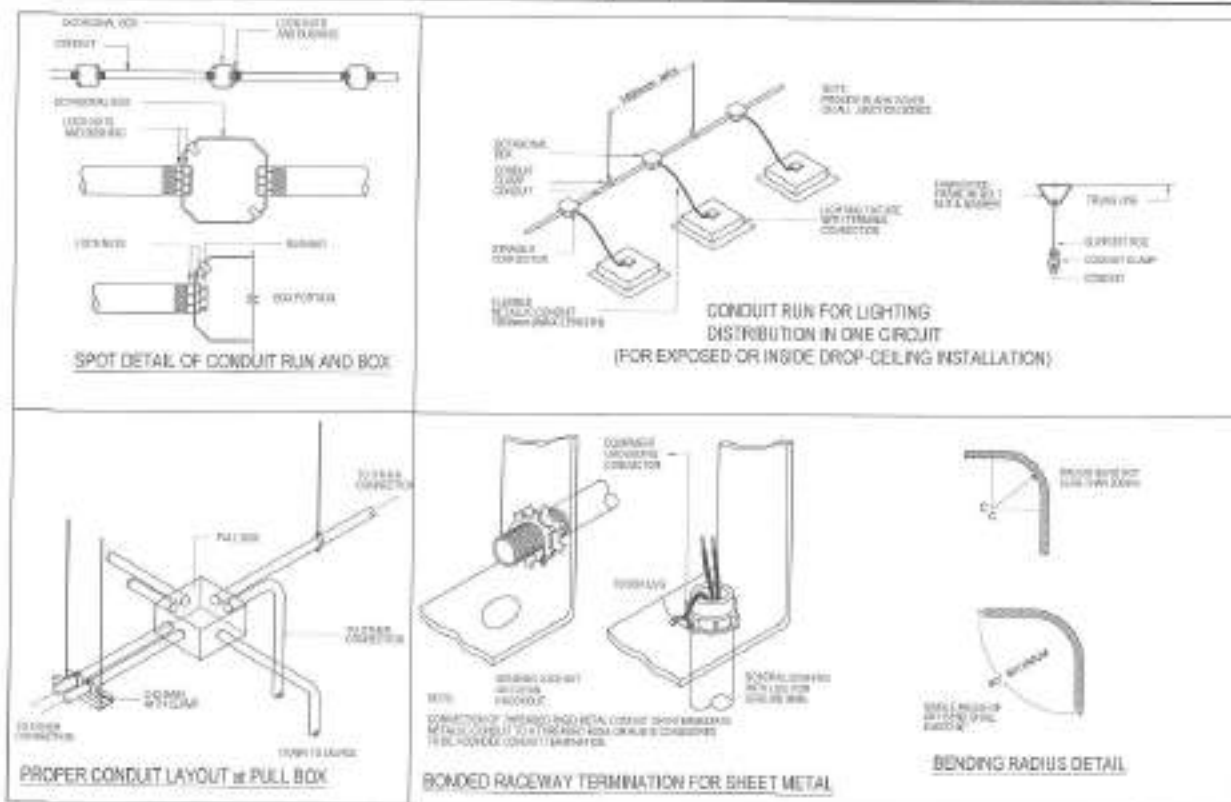

1 GENERAL NOTES

SCALE NTS

3 MISCELLANEOUS DETAILS

SCALE NTS



Regulating Division
Licensed as Branch
DEPARTMENT OF ENGINEERING
Office of the City Engineer, Quezon City
1000, Santa Rosa Drive
Cebu City, 6000

PROJECT TITLE:
PROPOSED REHABILITATION OF ELECTRICAL SYSTEM AT JUDGE FELICIANO BELMONTE SR. HIGH SCHOOL

LOCATION:
BRGY. NELY SPENT, DISTRICT 2, QUEZON CITY

DATE:
DESIGNED BY: *[Signature]*
CHECKED BY: *[Signature]*
REVISION NO.:


SUBMITTED BY:
[Signature]
ENGR. FREDERICKA OL. DE GUZMAN
HEAD, PLANNING & DESIGN DIVISION

RECOMMENDED BY APPROVAL:
[Signature]
ENGR. ROBERT L. BELTRAN
CHIEF, DEPARTMENT OF ENGINEERING

APPROVED BY:
HON. MA. JOSEFINA G. BELMONTE
CITY ENGINEER

SHEET CONTENT:
GENERAL NOTES AND SYMBOLS
MISCELLANEOUS DETAILS

SHEET NO.:
EL-01
07/37

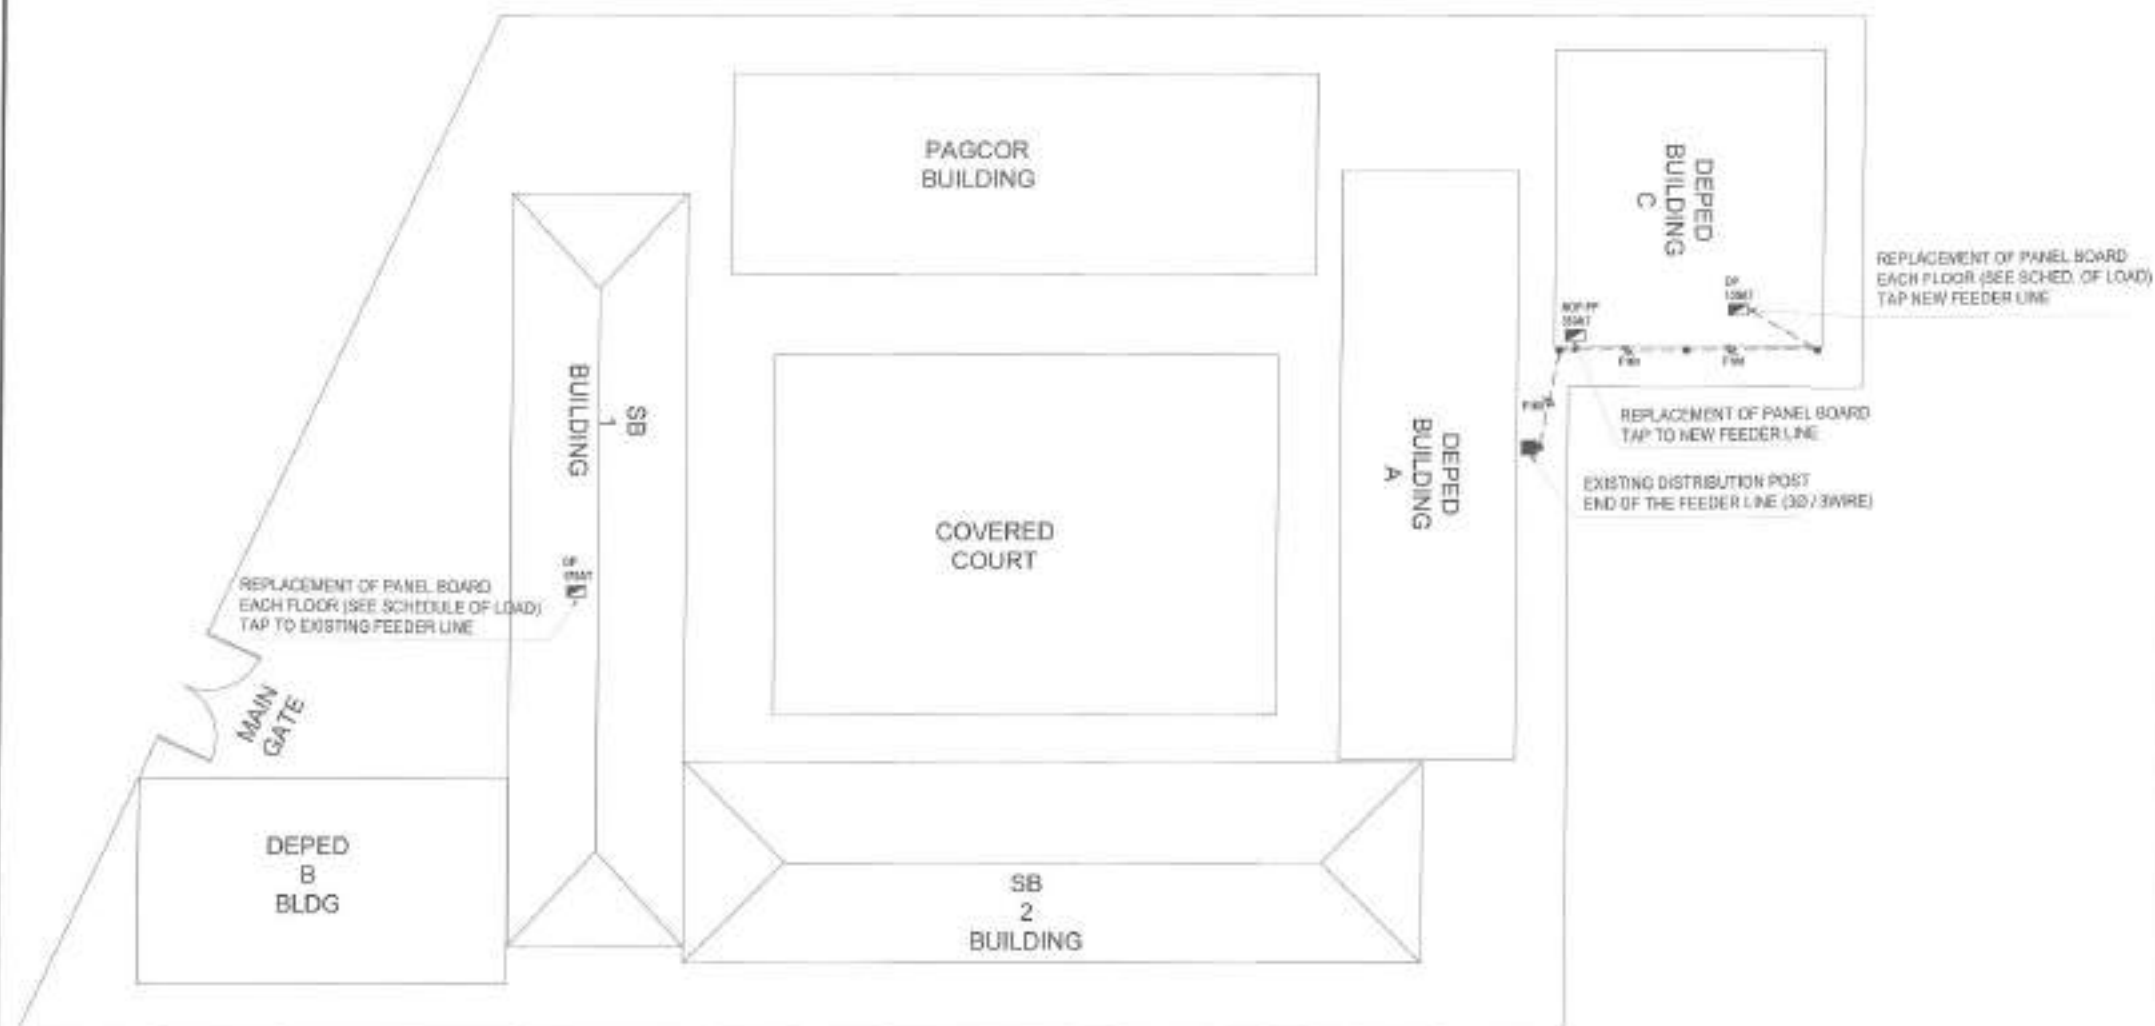

1 FEEDER LINE LAYOUT

SCALE: NTS

 <p>Republic of the Philippines Department of Engineering 1000 N. RIVER ST., 1000 N. RIVER ST. MANILA, PHILIPPINES 1000 Telephone: 100 2400 4000 E-mail: de@engr.gov.ph</p>	<p>PROJECT TITLE:</p> <p>PROPOSED REHABILITATION OF ELECTRICAL SYSTEM AT JUDGE FELICIANO BELMONTE SR. HIGH SCHOOL</p> <p>LOCATION:</p> <p>BARANGAY 1, DISTRICT 1, QUEZON CITY</p>	<p>DATE:</p> <p>DESIGNED BY: <i>Ch</i></p> <p>CHECKED BY: <i>Ch</i></p> <p>REVISION NO.</p>	<p>DRAWN BY: <i>Ch</i></p> <p>CHIEF ENGINEER: <i>Ch</i></p> <p>ENGR. FREDERICKA D. DE GUZMAN MANILA, PHILIPPINES 1000</p>	<p>RECOMMENDED APPROVAL:</p> <p><i>Ch</i></p> <p>ENGR. ROBERT L. BELTRAN C.E. (DEPARTMENT OF ENGINEERING)</p>	<p>APPROVED BY:</p> <p><i>Ch</i></p> <p>HON. MA. JOSEFINA G. BELMONTE CITY MAYOR</p>	<p>SHEET CONTENT:</p> <p>FEEDER LINE LAYOUT</p>	<p>SHEET NO.:</p> <p>EL-02 08/37</p>
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PANEL: DEPED B BUILDING: DISTRIBUTION PANEL (REPLACEMENT) - TAP TO EXISTING FEEDER LINE											
NAME: 12SAT, 200AF, 3P, 230V, MCCB											
CCT NO.	VOLTS	OUTLET		OTHER LOAD SERVICE	AMPERE LOAD			3P	VOLT AMPERE	CIRCUIT BREAKER	SIZE OF WIRE
		LB	CO		AB	CA	BC				
1	230			UP1	27.83				6400.00	40AT, 2P, MCCB	2 - 8.0mm² THHN + 1 - 5.0mm² TW (G) in 20mm² PVC
2	230			UP2	27.83				6400.00	40AT, 2P, MCCB	2 - 8.0mm² THHN + 1 - 5.0mm² TW (G) in 20mm² PVC
3	230			UP3			27.83		6400.00	40AT, 2P, MCCB	2 - 8.0mm² THHN + 1 - 5.0mm² TW (G) in 20mm² PVC
4	230			UP4		27.83			6400.00	40AT, 2P, MCCB	2 - 8.0mm² THHN + 1 - 5.0mm² TW (G) in 20mm² PVC
TOTAL					95.55	27.83	27.83	0.00	25600.00		
I = 95.55 x 1.732											
Feeder Line: 96.99 Amperes											
Use: 1 - 38mm² THHN + 1 - 10mm² TW (G) in 40mm² PVC											

PANEL: DEPED B BUILDING: UP1, UP2, UP3 AND UP4 (TYPICAL) (REPLACEMENT)											
NAME: 40AT, 100AF, 2P, 230V, MCCB											
CCT NO.	VOLTS	OUTLET		OTHER LOAD SERVICE	AMPERE LOAD			3P	VOLT AMPERE	CIRCUIT BREAKER	SIZE OF WIRE
		LD	CO		AB	CA	BC				
1	230	30			2.17				500	20AT, 2P, Bolt-On	2 - 3.5mm ² THHN + 1 - 2.0mm ² TW (G) in 20mm ² PVC
2	230	30			2.17				500	20AT, 2P, Bolt-On	2 - 3.5mm ² THHN + 1 - 2.0mm ² TW (G) in 20mm ² PVC
3	230	30			4.35				1000	20AT, 2P, Bolt-On	2 - 3.5mm ² THHN + 1 - 2.0mm ² TW (G) in 20mm ² PVC
4	230		30		4.35				1000	20AT, 2P, Bolt-On	2 - 3.5mm ² THHN + 1 - 2.0mm ² TW (G) in 20mm ² PVC
5	230		30		4.35				1000	20AT, 2P, Bolt-On	2 - 3.5mm ² THHN + 1 - 2.0mm ² TW (G) in 20mm ² PVC
6	230			12 - ORBIT FAN	5.22				1200	20AT, 2P, Bolt-On	2 - 3.5mm ² THHN + 1 - 2.0mm ² TW (G) in 20mm ² PVC
7	230			12 - ORBIT FAN	5.22				1200	20AT, 2P, Bolt-On	2 - 3.5mm ² THHN + 1 - 2.0mm ² TW (G) in 20mm ² PVC
8	230			SPARE							
TOTAL					27.83	0.00	0.00	0.00	6400.00		
I = 6400 / 230											
Feeder Line:											
Use: 1 - 8.0mm ² THHN + 1 - 5.0mm ² TW (G) in 20mm ² PVC											
27.83 Amperes											

1 SCHEDULE OF LOAD

SCALE: NTS.

 Department of Engineering Engineering Division City of Quezon	PROJECT TITLE:	DATE:	SUBMITTED BY:	PROPOSED APPROVAL:	APPROVED BY:	SHEET CONTENT:	SHEET NO.
	PROPOSED REHABILITATION OF ELECTRICAL SYSTEM AT JUDGE FELICIANO BELMONTE SR. HIGH SCHOOL	DESIGNED BY: RHM  CHECKED BY: RHM 	ENGR. FREDISWEN D. DE GUZMAN HEAD, PLANNING & DESIGN DIVISION	ENGR. ROBERT L. BELTRAN CHIEF, DEPARTMENT OF ENGINEERING	HON. MA. JOSEFINA G. BELMONTE CITY MAJOR	SCHEDULE OF LOAD	EL-04 10/37
LOCATION: BRGY. HOLY SPIRIT, DISTRICT 2, QUEZON CITY		REVISION NO.:					


PANEL: DEPED B BUILDING DISTRIBUTION PANEL - PP									
MAIN: 300V, 300AF, 3P, 230V, MCCB									
CIR NO.	VOLTS	OUTLET		OTHER LOAD SERVICE	AMPERE LOAD			CIRCUIT BREAKER	SIZE OF WIRE
		LD	ED		AB	CA	BC		
1	230			PP1	173.47			175AT, 2P, MCCB	2 - 80mm ² THHN + 1 - 22mm ² TW (G) in 50mm ² IMC
2	230			PP2		173.47		175AT, 2P, MCCB	2 - 80mm ² THHN + 1 - 22mm ² TW (G) in 50mm ² IMC
3	230			PP3			173.47	175AT, 2P, MCCB	2 - 80mm ² THHN + 1 - 22mm ² TW (G) in 50mm ² IMC
TOTAL					173.47	173.47	173.47	0.00	
					$I = 173.47 \times 1.732$				
					300.45 Amperes				
					Feeder Wire:				
					Use: 3 - 80mm ² THHN + 1 - 22mm ² TW (G) in 80mm ² IMC				

PANEL: DEPED B BUILDING PP1, PP2 AND PP3 (WELDING MACHINE)										
MAIN: 175AT, 200AF, 2P, 230V, MCCB										
UNIT NO.	DUTY CYCLE	FLA	GROUP OF WELDER	TYPE OF WELDING	COMPUTATION			TOTAL	CIRCUIT BREAKER	SIZE OF WIRE
1	40%	81.30A	100%	WELDING GENERATOR (500A-500A)	0.40	91.30	1.00	36.52	175AT, 2P, MCCB	2 - 34mm ² THHN + 1 - 8.0mm ² TW (G) in 25mm ² IMC
2	40%	81.30A	100%	WELDING GENERATOR (500A-500A)	0.40	91.30	1.00	36.52	175AT, 2P, MCCB	2 - 34mm ² THHN + 1 - 8.0mm ² TW (G) in 25mm ² IMC
3	40%	81.30A	85%	WELDING GENERATOR (500A-500A)	0.40	91.30	0.85	31.04	175AT, 2P, MCCB	2 - 34mm ² THHN + 1 - 8.0mm ² TW (G) in 25mm ² IMC
4	40%	81.30A	70%	WELDING GENERATOR (500A-500A)	0.40	91.30	0.70	25.56	175AT, 2P, MCCB	2 - 34mm ² THHN + 1 - 8.0mm ² TW (G) in 25mm ² IMC
5	40%	81.30A	60%	WELDING GENERATOR (500A-500A)	0.40	91.30	0.60	21.91	175AT, 2P, MCCB	2 - 34mm ² THHN + 1 - 8.0mm ² TW (G) in 25mm ² IMC
6	40%	81.30A	60%	WELDING GENERATOR (500A-500A)	0.40	91.30	0.60	21.91	175AT, 2P, MCCB	2 - 34mm ² THHN + 1 - 8.0mm ² TW (G) in 25mm ² IMC
TOTAL								173.47		
					373.47 Amperes					
Feeder Line:										
Use: 2 - 80mm ² THHN + 1 - 22mm ² TW (G) in 50mm ² IMC										

1 SCHEDULE OF LOAD

SCALE: NTS.


 <p>Pampanga State University Department of Engineering City Center Building 2, San Antonio, Pampanga Telephone: (045) 255-1000 E-mail address: engineering@psu.edu.ph</p>	PROJECT TITLE:	DATE:	SUBMITTED BY:	RECOMMENDING APPROVAL:	APPROVED BY:	DRAWN BY:	SHEET NO.	
	PROPOSED REHABILITATION OF ELECTRICAL SYSTEM AT JUDGE FELICIANO BELMONTE SR. HIGH SCHOOL	DESIGNED BY: AMH	CHECKED BY: RSN	ENGR. FREDERICKA CL. DE GUZMAN HEAD, PLANNING & DESIGN DIVISION	ENGR. ROBERT L. BELTRAN S.E. DEPARTMENT OF ENGINEERING	HON. MA. JOSEFINA G. BELMONTE CITY MAYOR	SCHEDULE OF LOAD	EL-05 11/37
	LOCATION: BRGY. HOLY SPIRIT, DISTRICT 2, QUEZON CITY	REVISION NO.:						

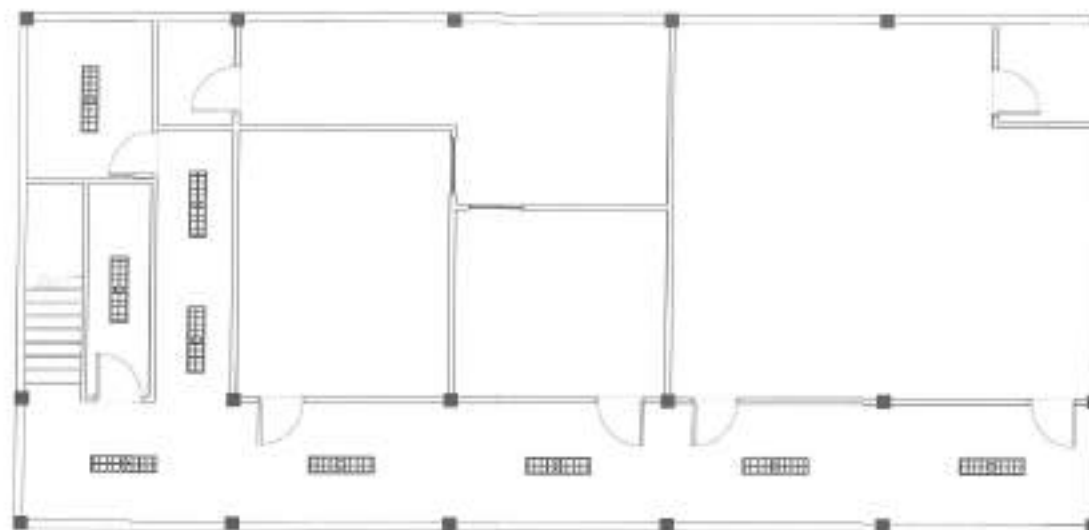

NOTE: REPLACEMENT OF LIGHTING FIXTURES

1 LIGHTING LAYOUT DEPED C BUILDING GROUND FLOOR PLAN

SCALE 1:100M

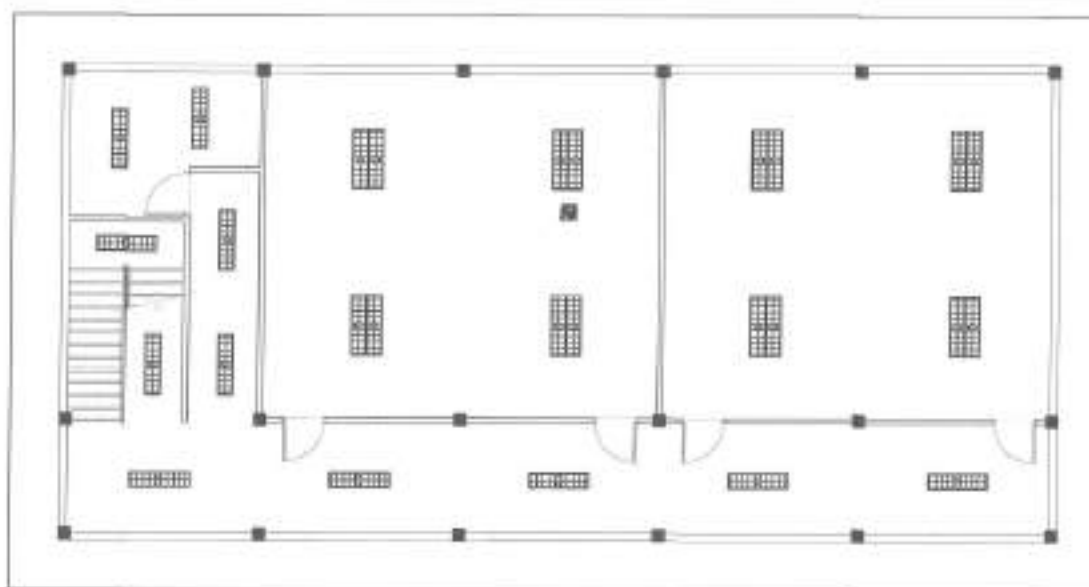

NOTE: REPLACEMENT OF LIGHTING FIXTURES


2 LIGHTING LAYOUT DEPED C BUILDING 2ND TO 4TH FLOOR PLAN

SCALE 1:100M



Engineering Division
 Engineering Division
 DEPARTMENT OF ENGINEERING
 1000 COMMERCE STREET, 10TH FLOOR
 OFFICE OF THE DEPUTY DEPARTMENT ENGINEER
 Cebu City, Philippines 6000
 Contact: (033) 444-4444


PROJECT TITLE	DATE	SUBMITTED BY	RECOMMENDING APPROVAL	APPROVED BY	SHEET CONTENT	SHEET NO.
PROPOSED REHABILITATION OF ELECTRICAL SYSTEM AT JUDGE FELICIANO BELMONTE SR. HIGH SCHOOL	DESIGNED BY:  CHECKED BY: 	ENGR. FREDERICK O. DE GUZMAN HEAD, PLANNING & DESIGN DIVISION	ENGR. ROBERT L. BELTRAN OC, DEPARTMENT OF ENGINEERING	HON. MA. JOSEFINA G. BELMONTTE CITY MAYOR	LIGHTING LAYOUT DEPED C BUILDING GROUND FLOOR PLAN LIGHTING LAYOUT DEPED C BUILDING 2ND TO 4TH FLOOR PLAN	EL-06 12 37
LOCATION BRGY. HOKI SPINT, DISTRICT 8, CAGAYAN CITY	REVISION NO.					

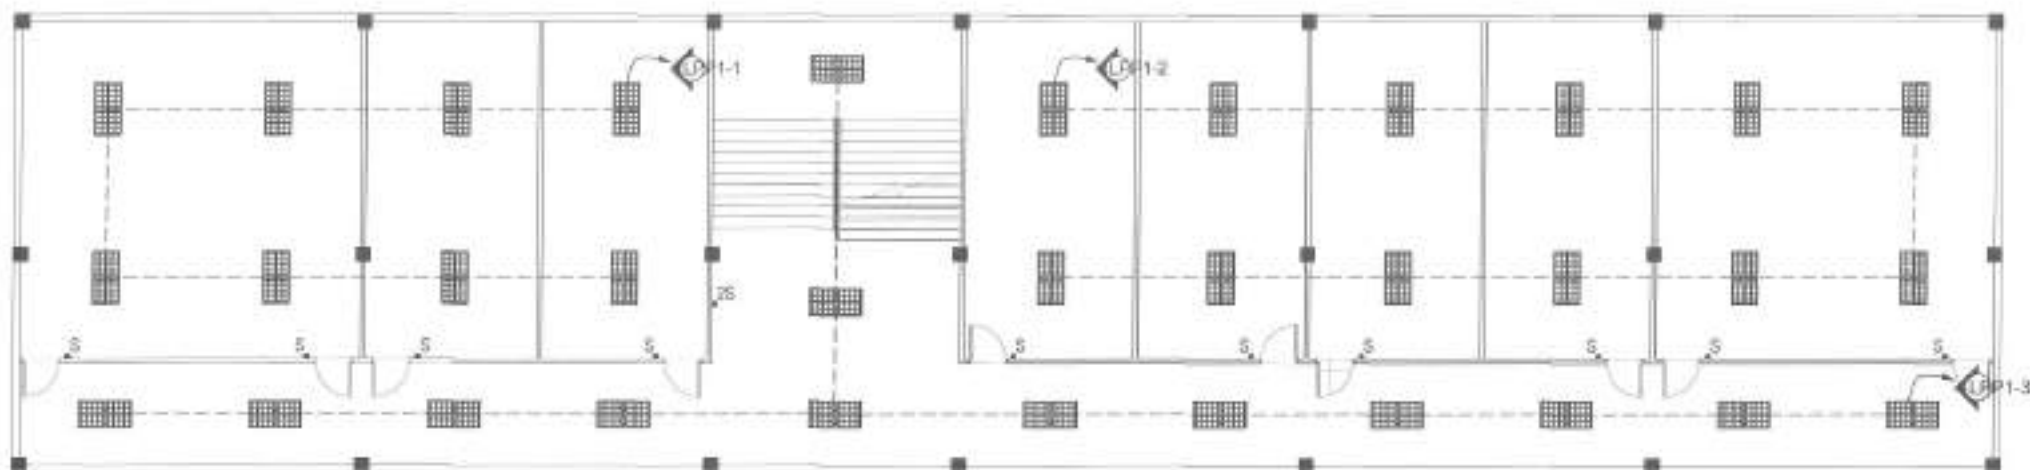

NOTE: REPLACEMENT OF LIGHTING FIXTURES AND RE-WIRING

1 LIGHTING LAYOUT SB-1 BUILDING GROUND FLOOR PLAN

SCALE 1:125M

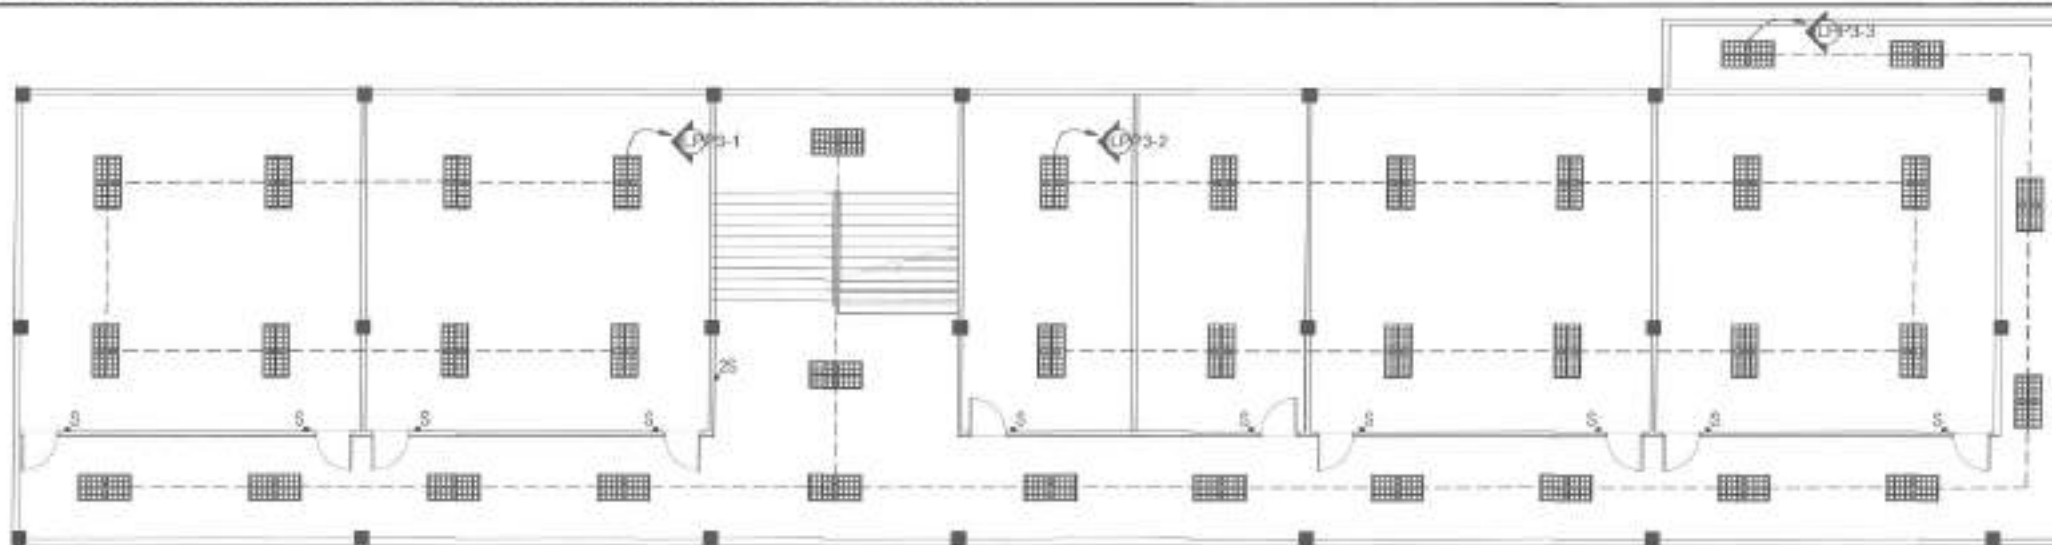

NOTE: REPLACEMENT OF LIGHTING FIXTURES AND RE-WIRING

2 LIGHTING LAYOUT SB-1 BUILDING 3RD FLOOR PLAN

SCALE 1:125M



Registering Engineer
Engineering Division
DEPARTMENT OF ENGINEERING
San Jose Building, 10th Floor, Quezon City
Office: 10th Floor, San Jose Bldg.
Tel: (02) 809-0041
E-mail: engin@quezoncity.gov.ph

PROJECT TITLE:
**PROPOSED REHABILITATION OF
ELECTRICAL SYSTEM AT JUDGE
FELICIANO BELMONTE SR. HIGH
SCHOOL**

LOCATION:
BROV. HOLY SPIRIT, DISTRICT 8 - QUEZON CITY

DATE:
DRAWN BY: JSM
CHECKED BY: [Signature]
REVISION NO.


SUBMITTED BY:
[Signature]
ENGR. FREDISWILDA D. DE GUZMAN
HEAD, PLANNING & DESIGN DIVISION

RECOMMENDED APPROVAL:
[Signature]
ENGR. ROBERT L. BELTRAN
MG. DIVISION OF ENGINEERING

APPROVED BY:
[Signature]
HON. MA. JOSEFINA G. DELMONTE
CITY MAJOR

SHEET CONTENT:
LIGHTING LAYOUT
SB-1 BUILDING
GROUND FLOOR
PLAN
LIGHTING LAYOUT
SB-1 BUILDING 3RD
FLOOR PLAN

SHEET NO.
**EL-07
13/37**

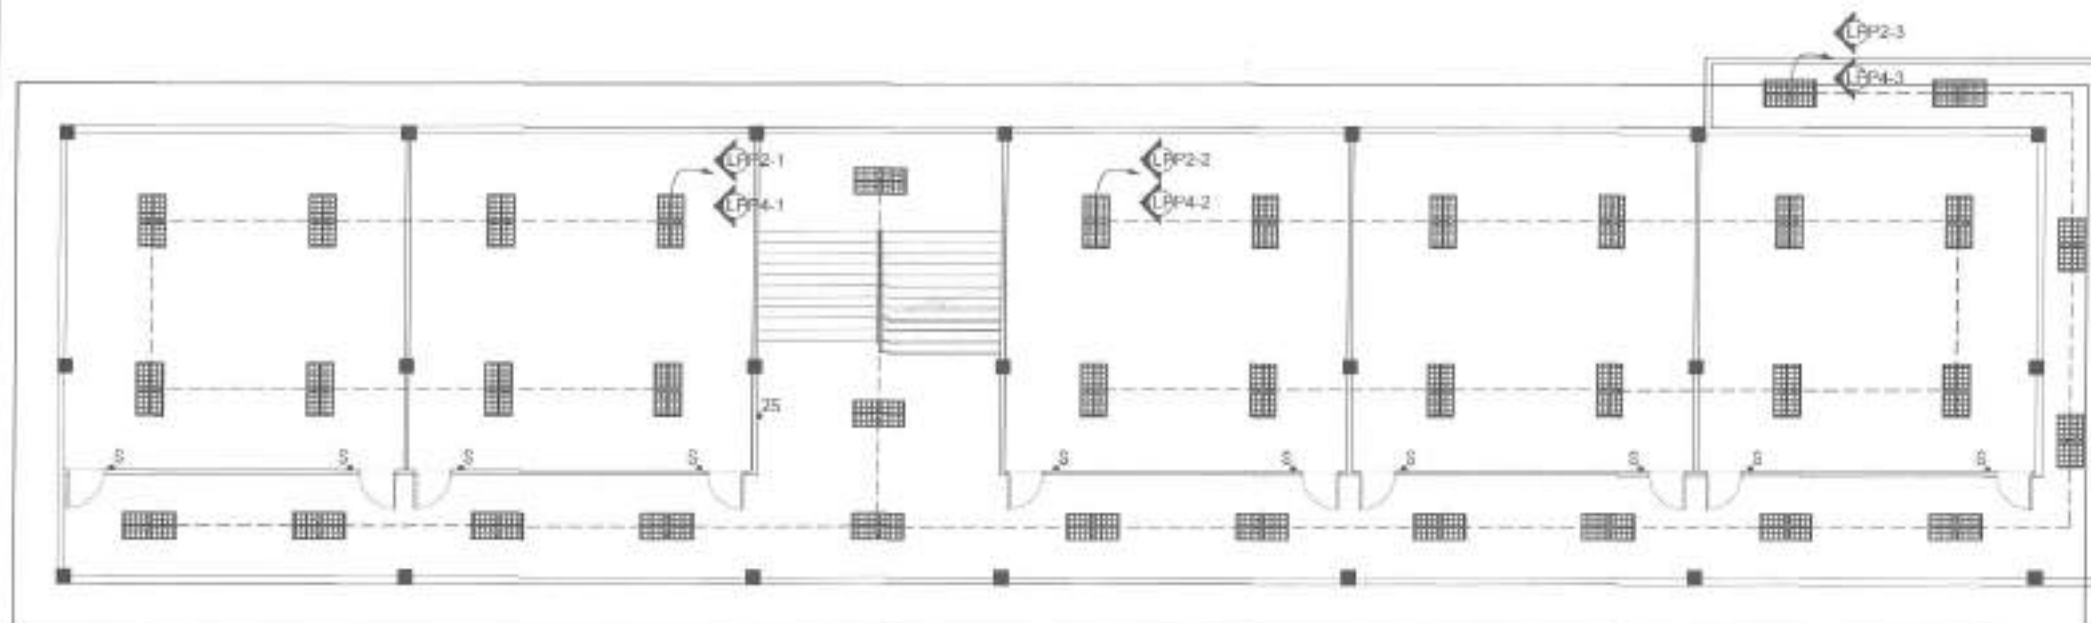

NOTE: REPLACEMENT OF LIGHTING FIXTURES AND RE-WIRING

1 LIGHTING LAYOUT SB-1 BUILDING 2ND AND 4TH FLOOR PLAN

SCALE 1:125M


 <p>Republic of the Philippines Department of Engineering Civil Engineering Division Office of the Division Engineer Quezon City, Philippines 1000</p>	<p>PROJECT TITLE:</p> <p>PROPOSED REHABILITATION OF ELECTRICAL SYSTEM AT JUDGE FELICIANO BELMONTE SR. HIGH SCHOOL</p> <p>LOCATION:</p> <p>BAGY. HOLY SPIRIT, DISTRICT 8, QUEZON CITY</p>	<p>DATE:</p> <p>DESIGNED BY: JMM</p> <p>CHECKED BY: JMM</p> <p>REVISION NO.:</p>	<p>SUBMITTED BY:</p> <p>ENGR. FREDERICKA D. DE GUZMAN HEAD, PLANNING & DESIGN DIVISION</p>	<p>RECOMMENDATION APPROVAL:</p> <p>ENGR. ROBERT L. BELTRAN DEPARTMENT OF ENGINEERING</p>	<p>APPROVED BY:</p> <p>HON. MA. JOSEFINA G. BELMONTE CITY MAYOR</p>	<p>SHEET CONTENT:</p> <p>LIGHTING LAYOUT 2ND & 4TH FLOOR PLAN</p>	<p>SHEET NO.</p> <p>EL-08 14 37</p>
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NOTE: REPLACEMENT OF LIGHTING FIXTURES

1 LIGHTING LAYOUT PAGCOR BUILDING GROUND FLOOR PLAN

SCALE 1:125M



NOTE: REPLACEMENT OF LIGHTING FIXTURES

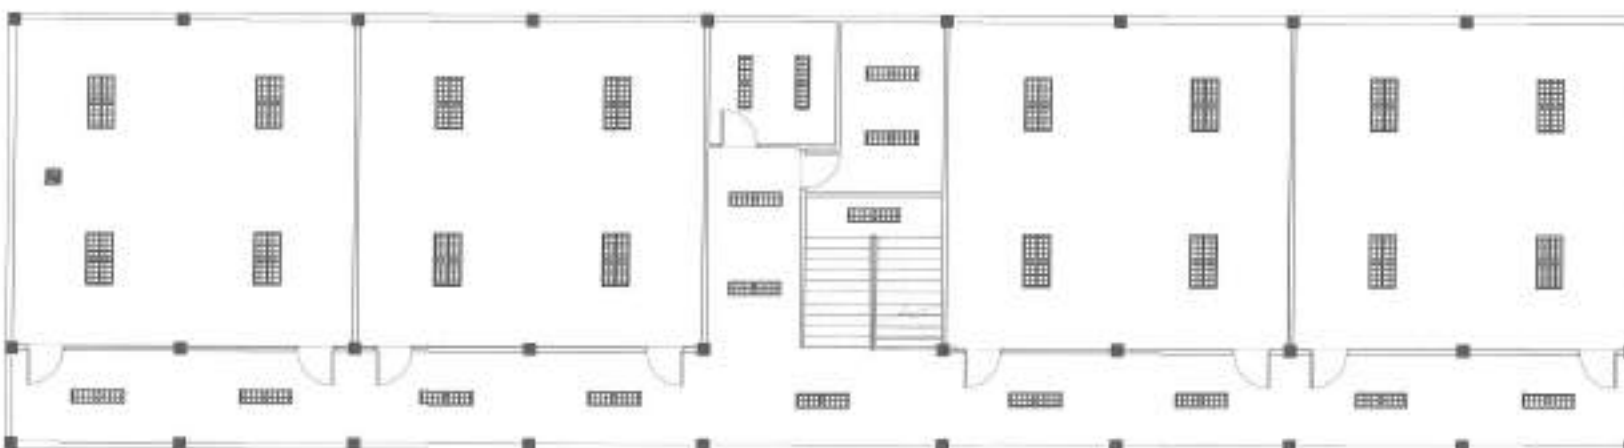2 LIGHTING LAYOUT PAGCOR BUILDING 2ND TO 4TH FLOOR PLAN

SCALE 1:125M



Republic of the Philippines
 Department of Engineering
 (The National Engineering Council, National Engineering Council of the Philippines)
 Office: 4th Floor, 10th Avenue, 10th Floor
 Telephone: +63 2 8866 0000

PROJECT TITLE:
**PROPOSED REHABILITATION OF
 ELECTRICAL SYSTEM AT JUDGE
 FELICIANO BELMONTE SR. HIGH
 SCHOOL**

LOCATION:
 BIST. HOLY SPIRIT, DISTRICT 2, QUEZON CITY

DATE:
 DESIGNED BY: *[Signature]*
 DRAWN BY: *[Signature]*
 CHECKED BY: *[Signature]*

REVISIONS:


DESIGNED BY:
ENGR. FREDERICK D. DE GUZMAN
 (SEAL, PLANTING & DESIGN OFFICE)

RECOMMENDING APPROVAL:
[Signature]
ENGR. ROBERT L. BELTRAN
 (SEAL, PLANTING & DESIGN OFFICE)

APPROVED BY:
HON. MA. JOSEFINA O. BELMONTE
 CITY SAVOR

SHEET CONTENT:
 LIGHTING LAYOUT
 PAGCOR BUILDING
 GROUND FLOOR
 PLAN
 LIGHTING LAYOUT
 PAGCOR BUILDING
 2ND TO 4TH FLOOR
 PLAN

SHEET NO:
**EL-09
 15 37**

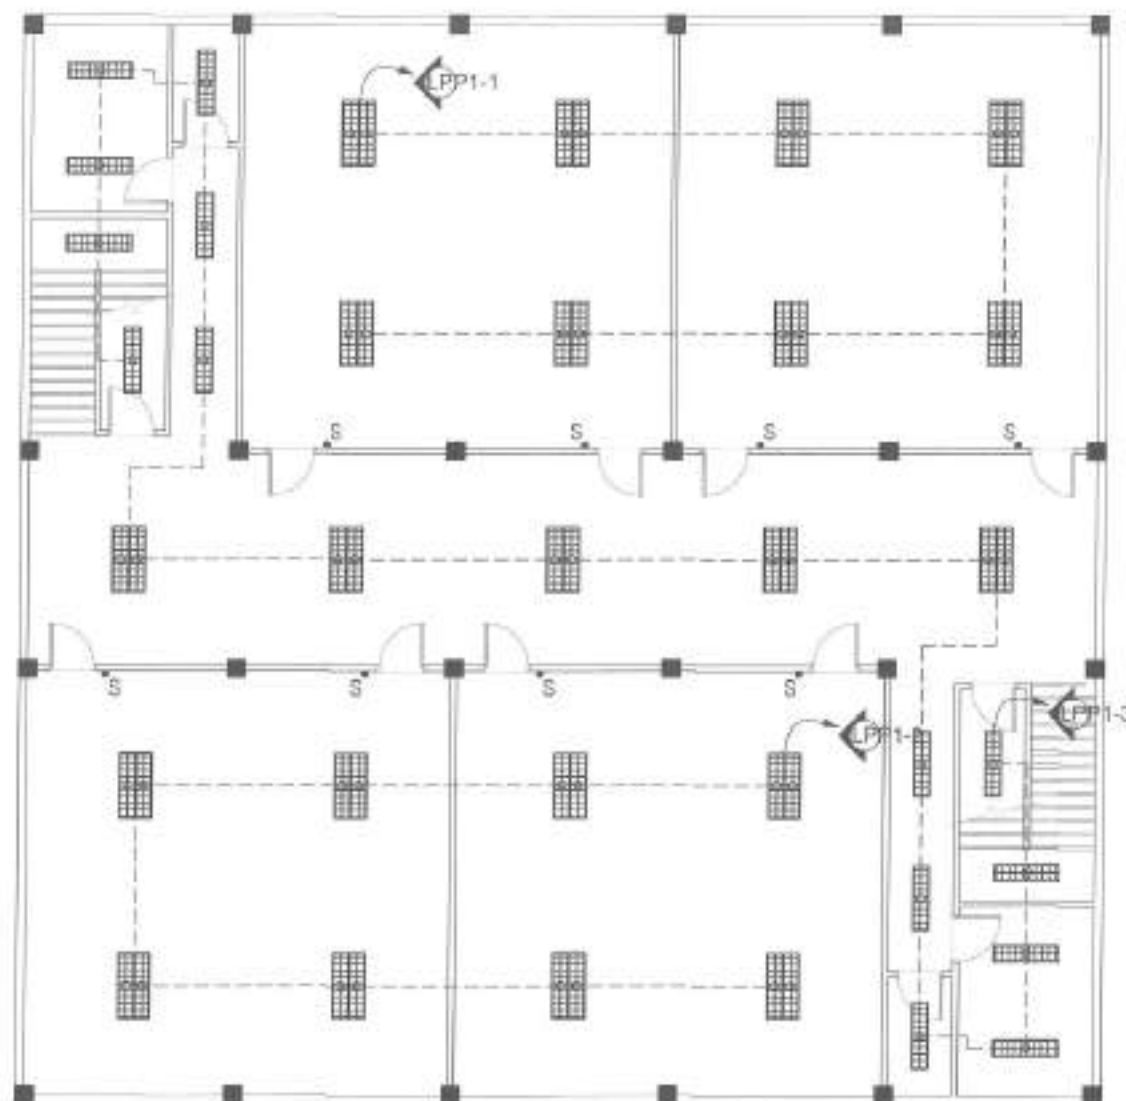

NOTE: REPLACEMENT OF LIGHTING FIXTURE AND RE-WIRING

1 LIGHTING LAYOUT DEPED B BUILDING GROUND FLOOR PLAN

SCALE 1:100M



Republic of the Philippines
Department of Engineering
Civil Engineering Division Office
DepEd Division Office - Marikina City
DepEd Division Office - Marikina City
DepEd Division Office - Marikina City

PROJECT TITLE:
**PROPOSED REHABILITATION OF
ELECTRICAL SYSTEM AT JUDGE
FELICIANO BELMONTE SR. HIGH
SCHOOL**

LOCATION:
BSPV, HOLY SPIRIT, DISTRICT 2, MARIKINA CITY

DATE:

DESIGNED BY: JMM
CHECKED BY: JMM
DATE: 10/10/2023

REVISION NO:

SUBMITTED BY:

ENGR. FREDERICKA D. DE GUZMAN
HEAD, PLANNING & DESIGN DIVISION

RECOMMENDING APPROVAL:

ENGR. ROBERT L. BELTRAN
CH. DEPARTMENT OF ENGINEERING

APPROVED BY:


HON. MA. JOSEFINA S. BELMONTE
CITY ENGINEER

SHEET CONTENT:

LIGHTING LAYOUT
CERCTO BUILDING
GROUND FLOOR
PLAN

SHEET NO:

EL-10
16 37

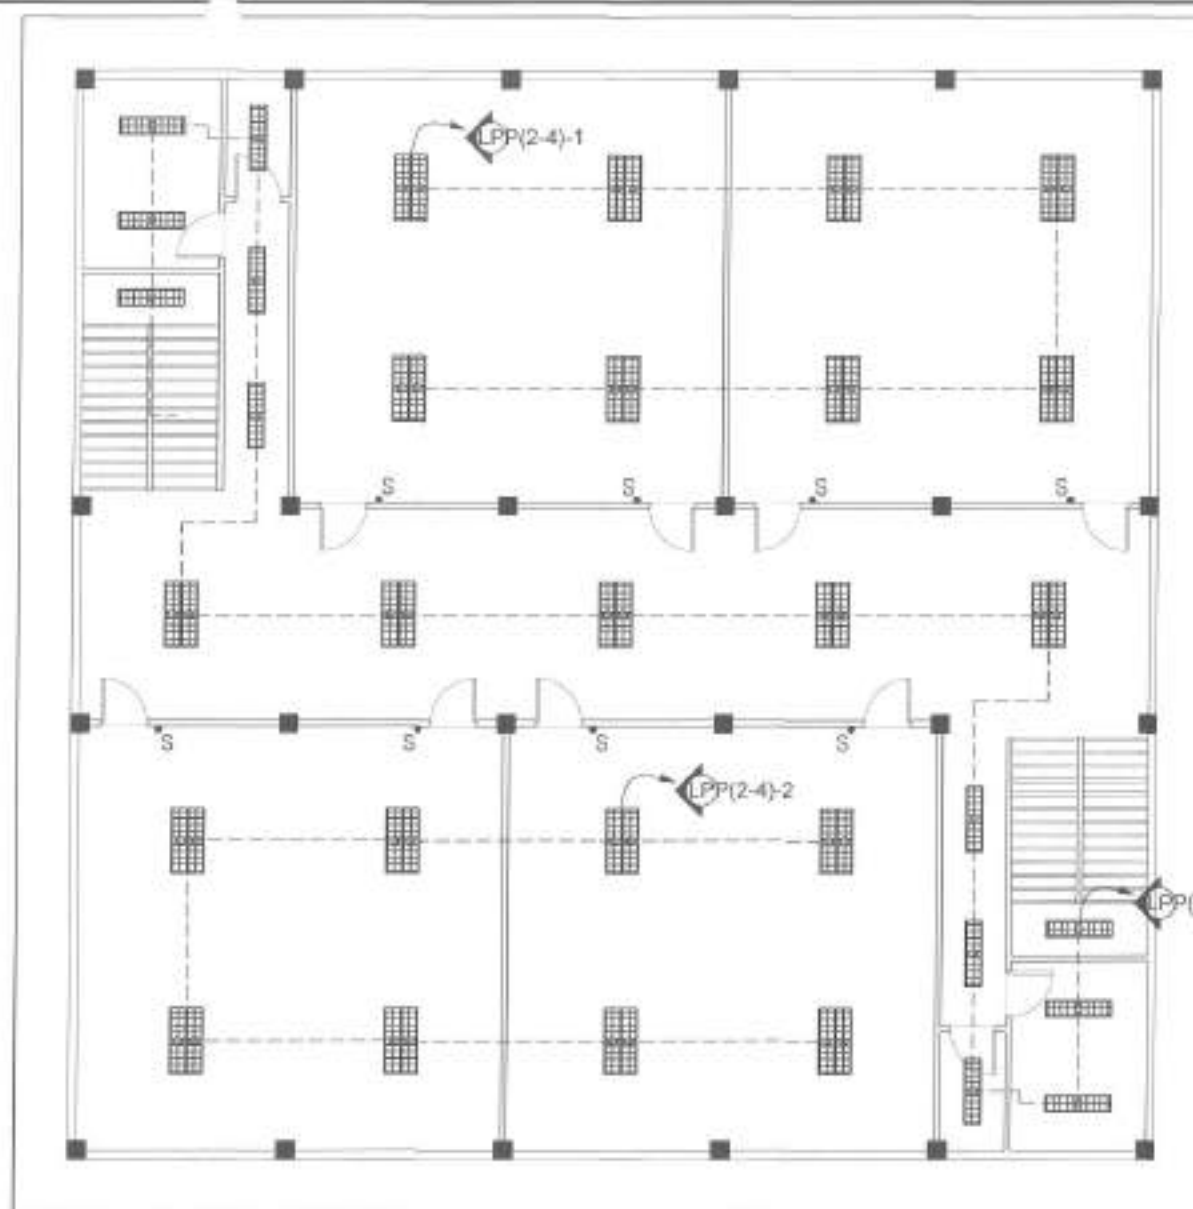

NOTE: REPLACEMENT OF LIGHTING FIXTURE AND RE-WIRING

1 LIGHTING LAYOUT DEPED B BUILDING 2ND TO 4TH FLOOR PLAN

SCALE 1:100M



Republic of the Philippines
Legislative Department
DEPARTMENT OF ENGINEERING
1001 Corner Building 1-10, 11th Floor, 12th Floor
Cebu, Cebu City 6000, Cebu, Philippines
Tel: (033) 255-1111
Fax: (033) 255-1111

PROJECT TITLE:
**PROPOSED REHABILITATION OF
ELECTRICAL SYSTEM AT JUDGE
FELICIANO BELMONTE SR. HIGH
SCHOOL**

DATE:

DESIGNED BY: JMM

DRAWN BY: JMM
CHECKED BY: JMM

SUBMITTED BY:

ENGR. FREDISWILA D. DE GUZMAN
HEAD PLANNING & DESIGN DIVISION

RECOMMENDING APPROVAL:

ENGR. ROBERT L. BELTRAN
CHIEF, DEPARTMENT OF ENGINEERING

APPROVED BY:


HON. RA. JOSEFINA G. BELMONTE
CITY MAYOR

SHEET CONTENT:

LIGHTING LAYOUT
OF DEPED B BUILDING
2ND TO 4TH FLOOR
PLAN

SHEET NO.


EL-11
17/37

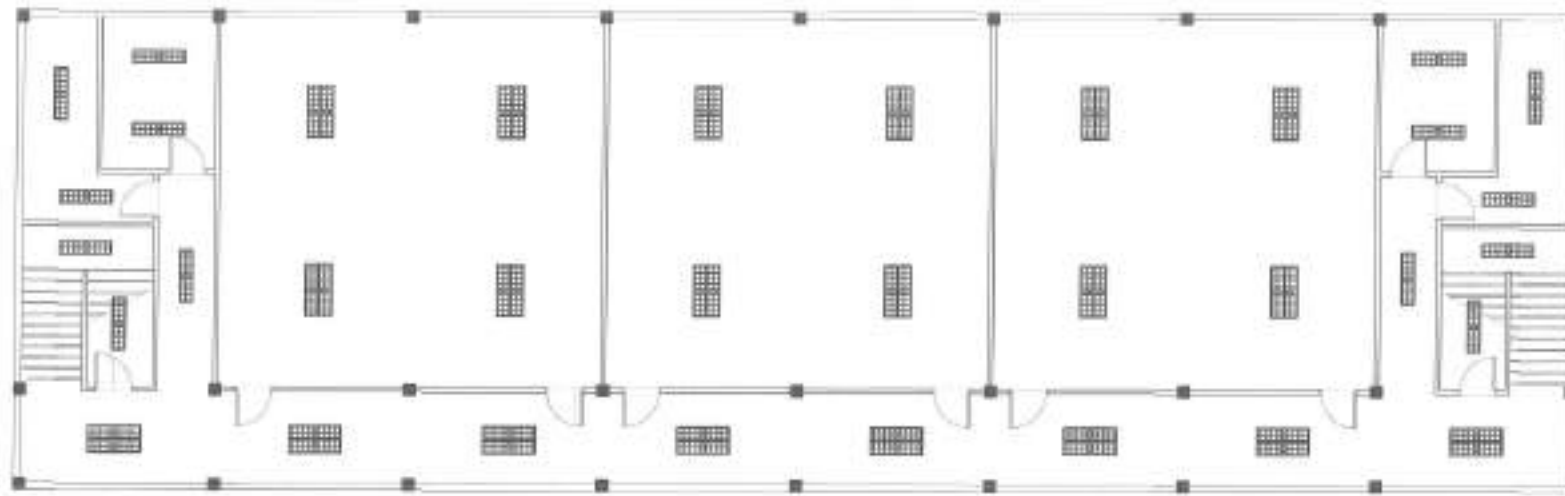

NOTE: REPLACEMENT OF LIGHTING FIXTURES

1 LIGHTING LAYOUT DEPED A BUILDING GROUND TO 3RD FLOOR PLAN

SCALE 1:125M

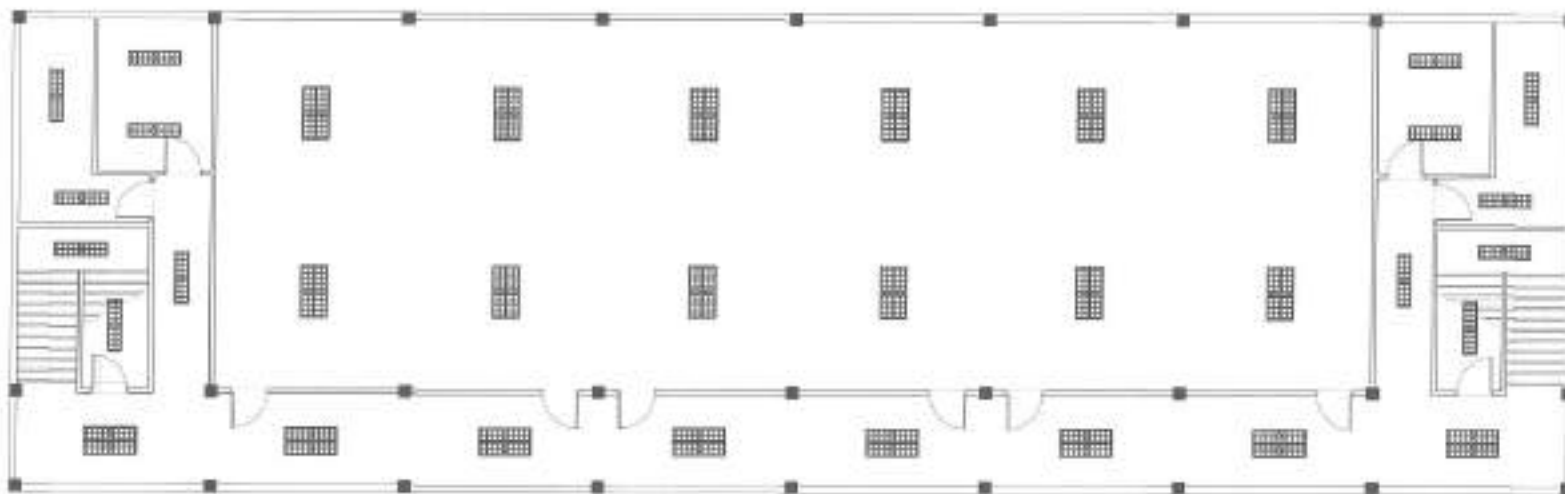

NOTE: REPLACEMENT OF LIGHTING FIXTURES

2 LIGHTING LAYOUT DEPED A BUILDING 4TH FLOOR PLAN

SCALE 1:125M



Republika ng Pilipinas
Lungsod ng Quezon
DEPARTMENT OF ENGINEERING
Quezon City
Quezon City 1105 Quezon City
Telephone: (02) 899-1234
E-mail: deeng@deped.gov.ph

PROJECT TITLE:

**PROPOSED REHABILITATION OF
ELECTRICAL SYSTEM AT JUDGE
FELICIANO BELMONTE SR. HIGH
SCHOOL**

LOCATION:

BRTS, HOLY SPIRIT, DISTRICT 2, QUEZON CITY

DATE:

DESIGNED BY: RSM

[Signature]
CHECKED BY: RSM

PROJECT NO.:

SUBMITTED BY:

ENGR. FREDERICK A. DE GUZMAN
HEAD, PLANNING & DESIGN DIVISION

RECOMMENDING OFFICIAL:

[Signature]
ENGR. ROBERT L. BELTRAN
CHIEF, DEPARTMENT OF ENGINEERING

APPROVED BY:


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HON. MA. JOSEFINA G. BELMONTE
CITY MAYOR

SHEET CONTENT:

LIGHTING LAYOUT
DEPED A BUILDING
GROUND TO 3RD
FLOOR PLAN
LIGHTING LAYOUT
DEPED A BUILDING
4TH FLOOR PLAN

SHEET NO.:


EL-12
18/37

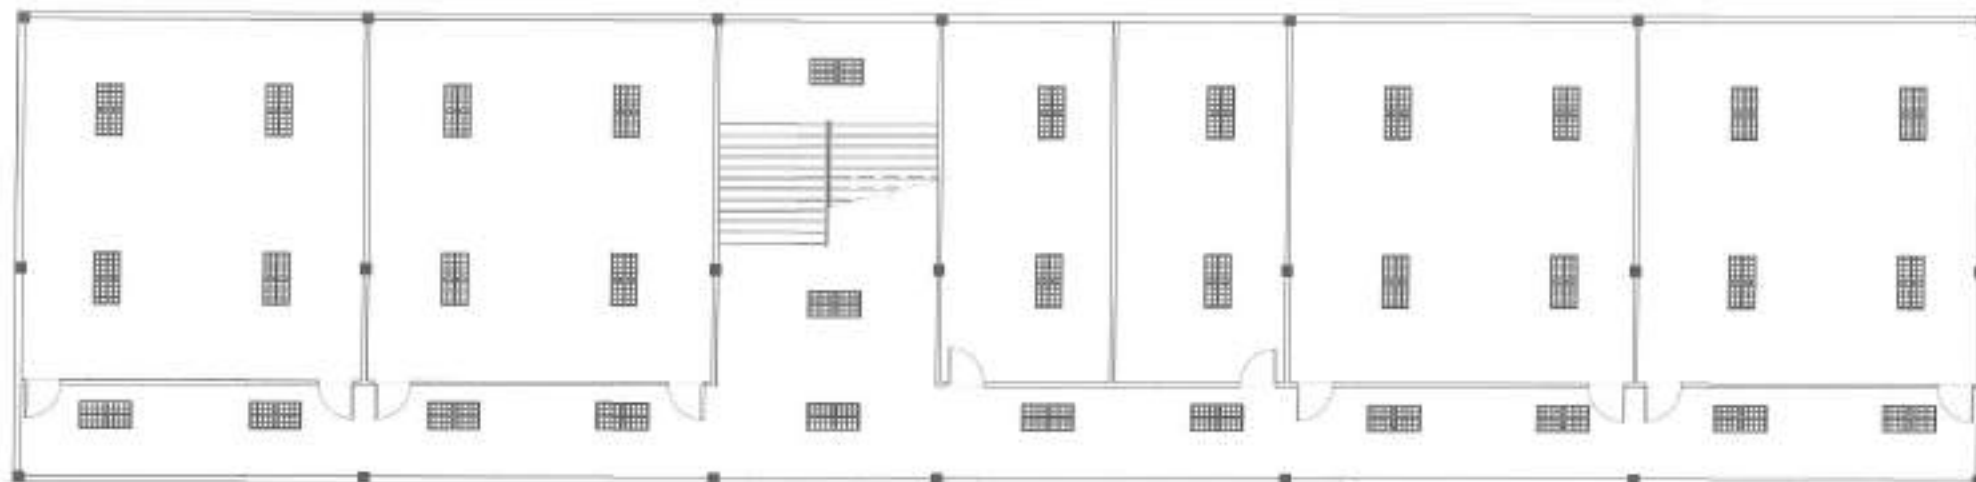

NOTE: REPLACEMENT OF LIGHTING FIXTURES

1 LIGHTING LAYOUT SB-2 BUILDING GROUND AND 3RD FLOOR PLAN

SCALE 1:125M

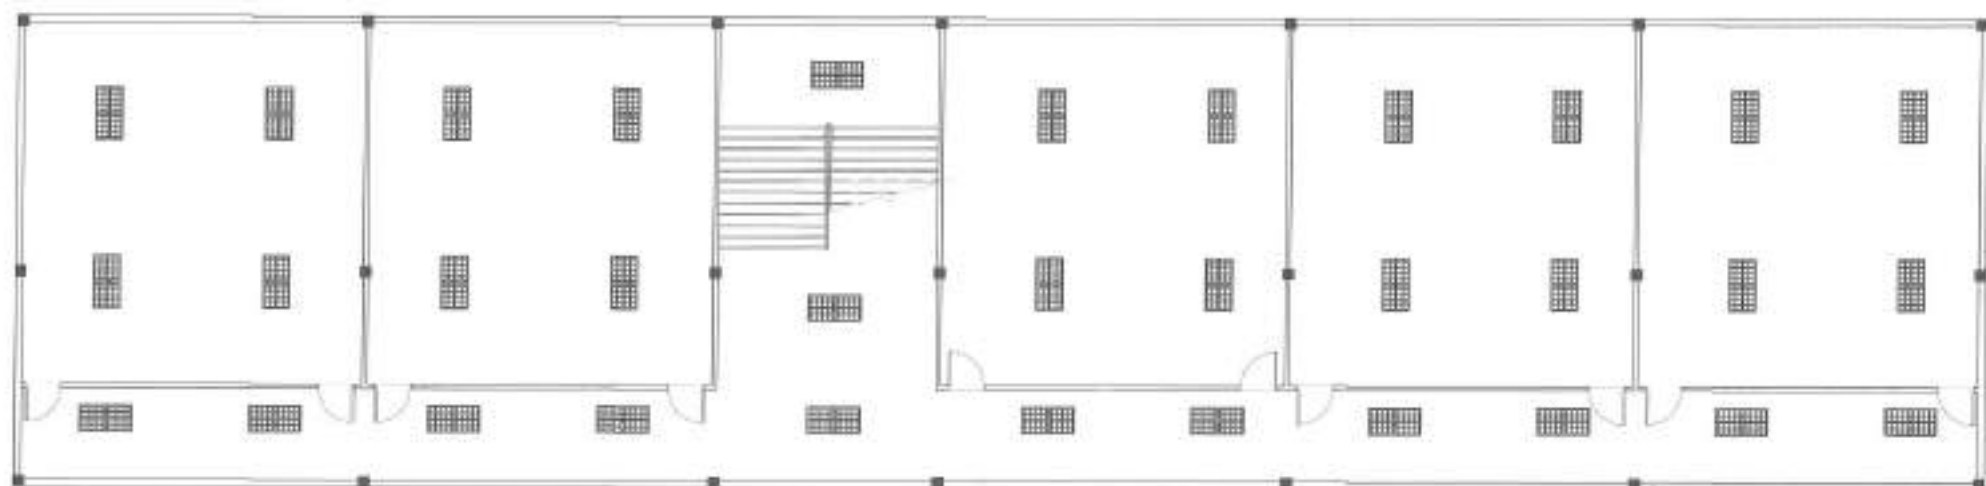

NOTE: REPLACEMENT OF LIGHTING FIXTURES

2 LIGHTING LAYOUT SB-2 BUILDING 2ND AND 4TH FLOOR PLAN

SCALE 1:125M



Republic of the Philippines
Lungsod ng Cebu
DEPARTMENT OF ENGINEERING
City Center Building 5, Corrales, Cebu City
Telephone: (032) 858-4347
Email: deo@cebu.gov.ph

PROJECT TITLE

PROPOSED REHABILITATION OF
ELECTRICAL SYSTEM AT JUDGE
FELICIANO BELMONTE SR. HIGH
SCHOOL

LOCATION

GRV. HOLY SPIRIT, DISTRICT 3, CEBU CITY

DATE

DESIGNED BY: AMM

DESIGNED BY: AMM
CHECKED BY: RCM

REVISIONS

SUBMITTED BY:

ENGR. FREDSWAN D. DE GUZMAN
HEAD, PLANNING & DESIGN DIVISION

RECOMMENDING APPROVAL:

ENGR. ROBERT L. BELTRAN
DEC, DEPARTMENT OF ENGINEERING

APPROVED BY:


HON. NA. JOSEFINA G. BELMONTE
CITY MAYOR

SHEET CONTENT

LIGHTING LAYOUT
SB-2 BUILDING
GROUND AND 3RD
FLOOR PLAN
LIGHTING LAYOUT
SB-2 BUILDING 2ND
AND 4TH FLOOR PLAN

SHEET NO.

EL-13
19/37

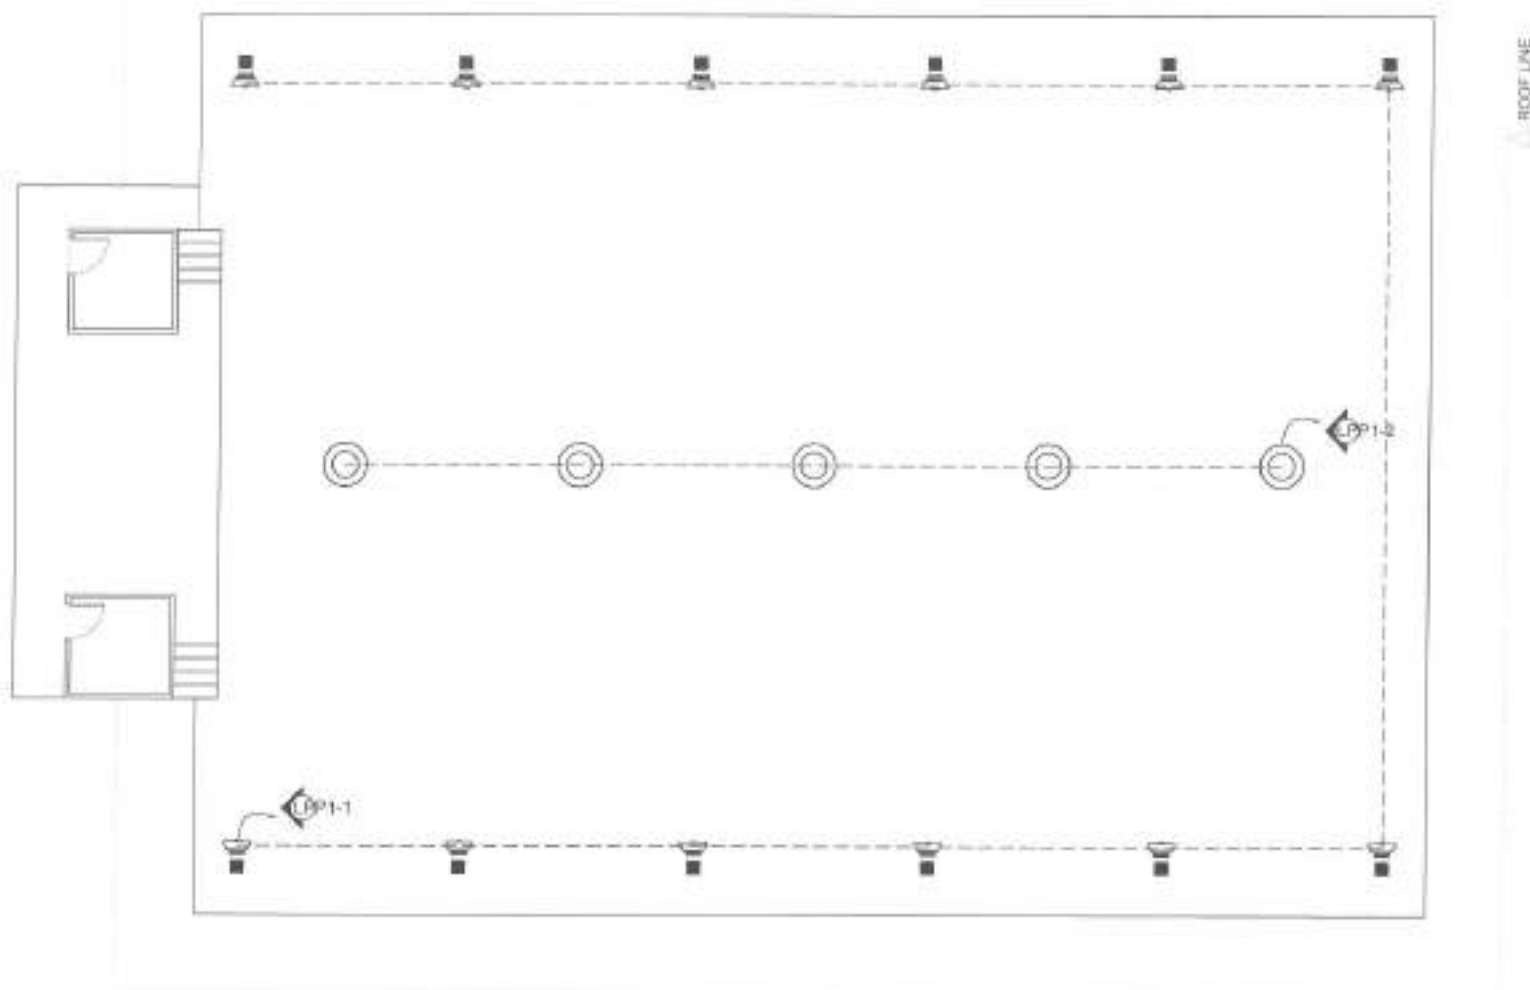


NOTE: REPLACEMENT OF LIGHTING FIXTURE AND RE-WIRING

1 LIGHTING LAYOUT COVERED COURT

SCALE 1:125M

<p>Excellence by Design Engineering Division DEPARTMENT OF ENGINEERING 100 Center Street 5th Floor New York, NY 10038 Tel: 472-2984392 Fax: 472-2984393</p>	PROJECT TITLE	DATE	SUBMITTED BY	RECOMMENDING APPROVAL	APPROVED BY	SHEET COUNT	SHEET NO.
	PROPOSED REHABILITATION OF ELECTRICAL SYSTEM AT JUDGE FELICIANO BELMONTE SR. HIGH SCHOOL	DESIGNED BY: AMM DRAWN BY: WAK CHECKED BY: RDN 	ENGR. FREDISMANA DL. DE GUZMAN HEAD, PLUMBING & DESIGN DIVISION	ENGR. ROBERT L. BELTRAM CH. DEPARTMENT OF ENGINEERING	HON. WA. JOSEFINA G. BELMONTE DISTRICT CLERK	LIGHTING LAYOUT COVERED COURT	EL-14 20 / 37
LOCATION	PROJECT NO.						
880V. HOLY SPIRIT, DISTRICT 8, QUEENS CITY							

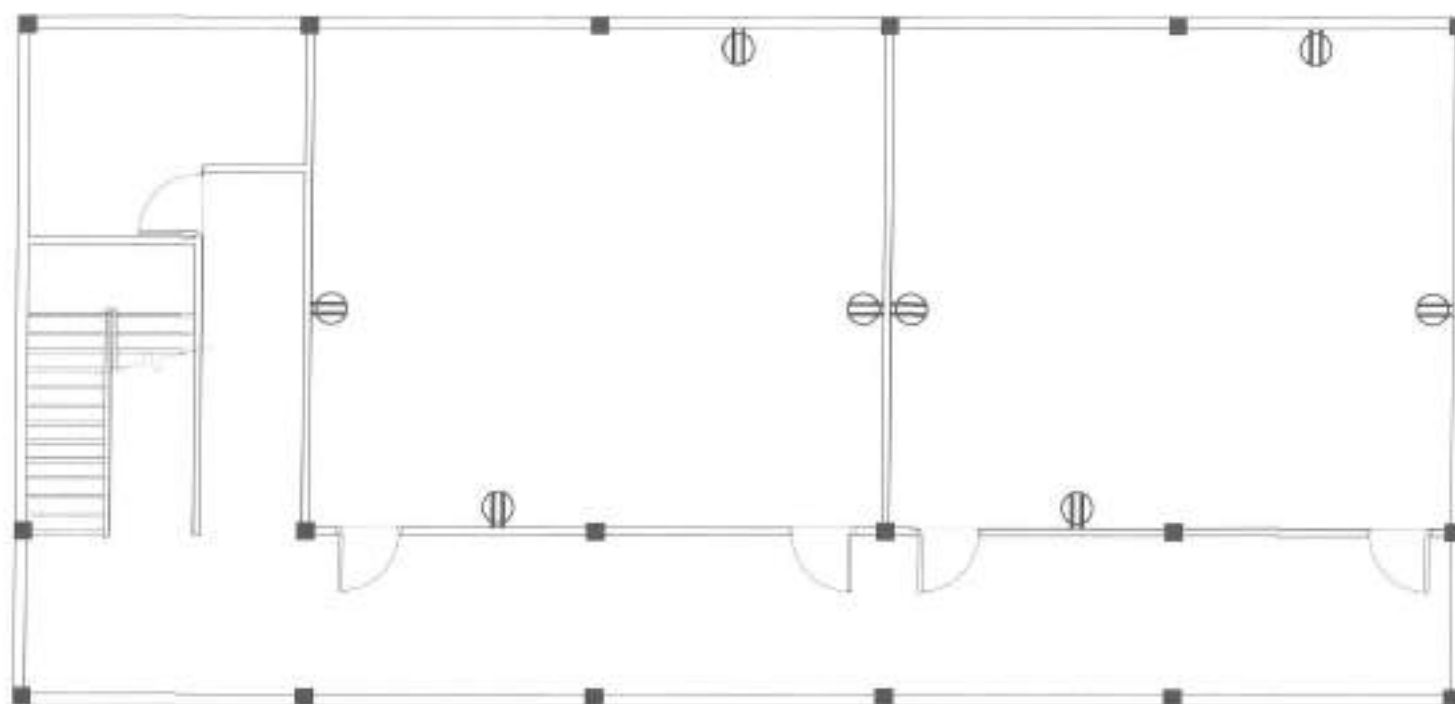


NOTE: REPLACEMENT OF CONVENIENCE OUTLET

1 POWER LAYOUT DEPED C BUILDING 2ND TO 4TH FLOOR PLAN

SCALE 1:100W


 <p> Republic of the Philippines Department of Engineering Office of the Director General Office of the Chief Engineer Office of the Assistant Chief Engineer Office of the Assistant Chief Engineer Office of the Assistant Chief Engineer </p>	PROJECT TITLE: PROPOSED REHABILITATION OF ELECTRICAL SYSTEM AT JUDGE FELICIANO BELMONTE SR. HIGH SCHOOL	DATE: EXAMINED BY: <i>[Signature]</i> DRAWN BY: <i>[Signature]</i> CHECKED BY: <i>[Signature]</i>	SUBMITTED BY: <i>[Signature]</i> ENGR. FREDERICK D. DE GUZMAN HEAD, PLANNING & DESIGN DIVISION	RECOMMENDING APPROVAL: <i>[Signature]</i> ENGR. ROBERT L. BELTRAN DEPT. CHIEF OF ENGINEERING	APPROVED BY: <i>[Signature]</i> HON. MA. JOSEFINA G. BELMONTE CITY MAYOR	SHEET CONTENT: POWER LAYOUT DEPED C BUILDING 2ND TO 4TH FLOOR PLAN	SHEET NO.: EL-15 21 37
	LOCATION: BMDY. HOLY SPIRIT DISTRICT 2, DAVAO CITY	REVISIONS:					

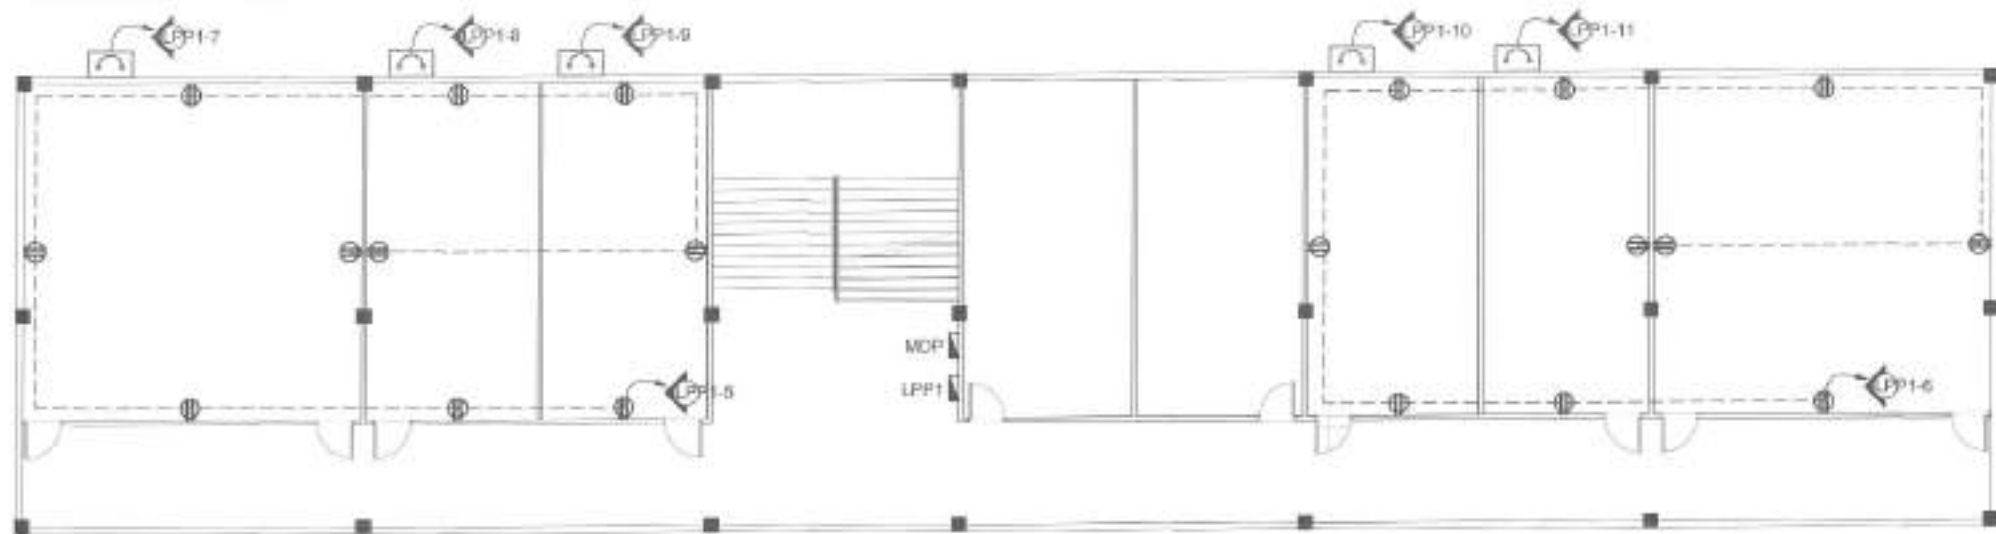

NOTE: REPLACEMENT OF PANEL BOARD, CONVENIENCE OUTLET AND RE-WIRING

1 POWER LAYOUT SB-1 BUILDING GROUND FLOOR PLAN

SCALE 1:125M

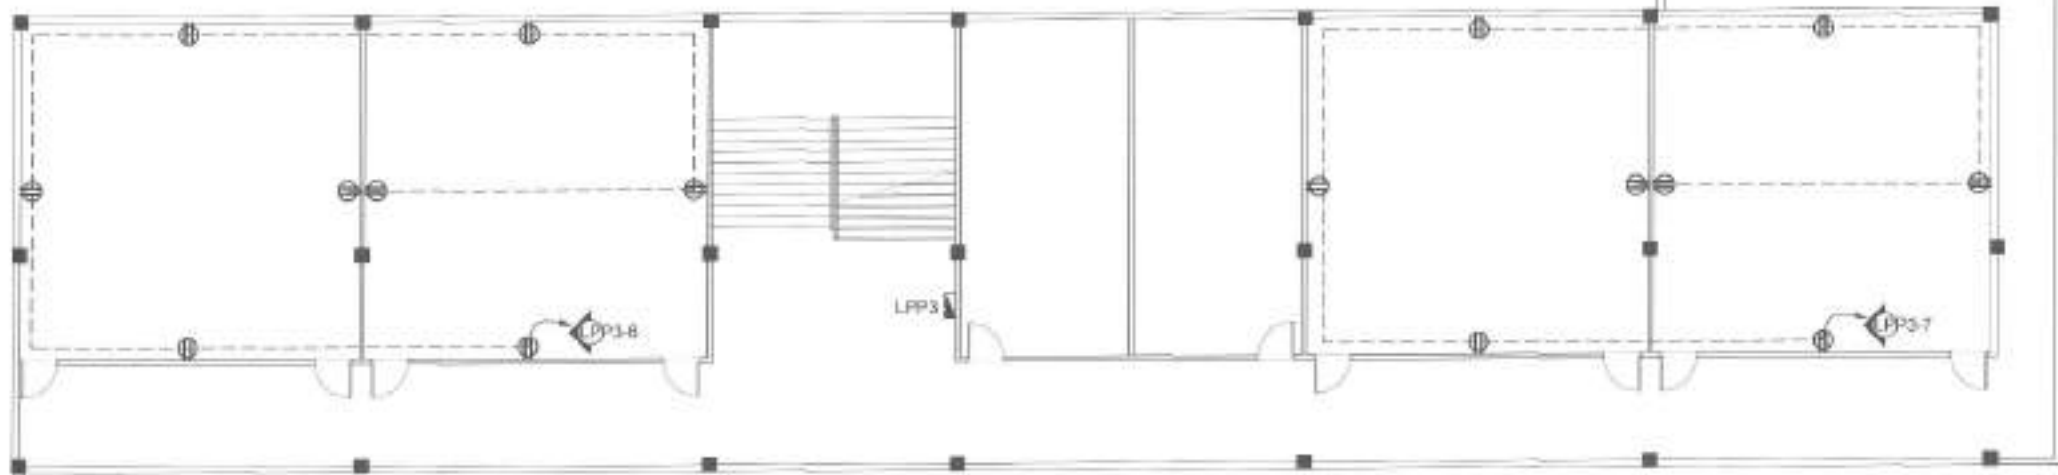

NOTE: REPLACEMENT OF PANEL BOARD CONVENIENCE OUTLET AND RE-WIRING

2 POWER LAYOUT SB-1 BUILDING 3RD FLOOR PLAN

SCALE 1:125M



Republic of the Philippines
 Department of Engineering
 Quezon City
 Division Office - Quezon City
 Division Office - Quezon City
 Division Office - Quezon City

PROJECT TITLE:
**PROPOSED REHABILITATION OF
 ELECTRICAL SYSTEM AT JUDGE
 FELICIANO BELMONTE SR. HIGH
 SCHOOL**

LOCATION:
 BRGY. HOLY SPIRIT, DISTRICT 6, QUEZON CITY

DATE:

DESIGNED BY: EMM
 DRAWN BY: VSE
 CHECKED BY: EMM

REVISION NO.:

SUBMITTED BY:

ENGR. FREDERICKA DL. DE GUZMAN
 HEAD, PLANNING & DESIGN DIVISION

RECOMMENDING APPROVAL:

ENGR. ROBERT L. BUSTAMANTE
 CHIEF, DIVISION OF ENGINEERING

APPROVED BY:


HON. RA. JOSEFINA G. BELMONTE
 CITY ENGINEER

SHEET CONTENT:

POWER LAYOUT SB-1
 BUILDING GROUND
 FLOOR PLAN
 POWER LAYOUT SB-1
 BUILDING 3RD FLOOR
 PLAN

SHEET NO.:

EL-16
 22 37

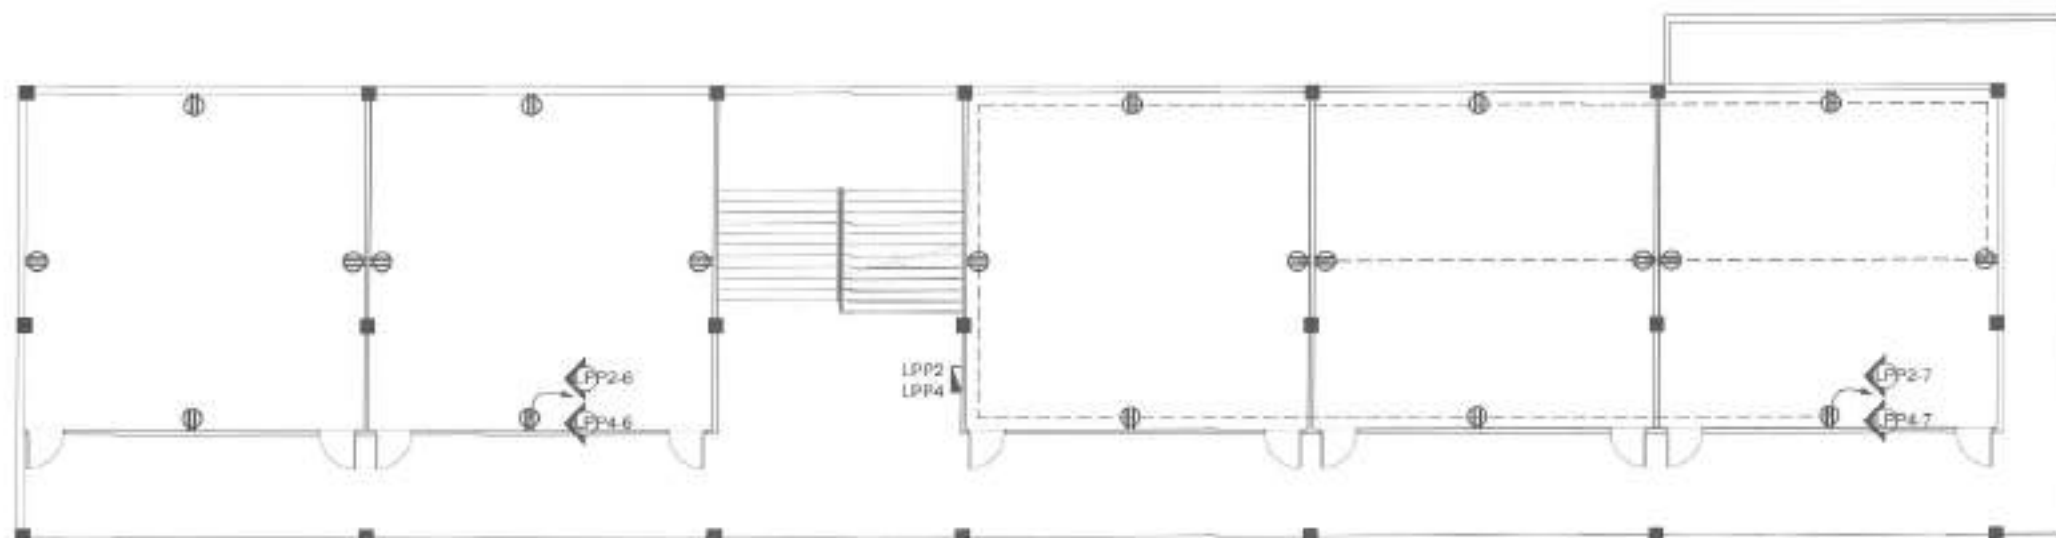


NOTE: REPLACEMENT OF PANEL BOARD, CONVENIENCE OUTLET AND RE-WIRING

1 POWER LAYOUT SB-1 BUILDING 2ND AND 4TH FLOOR PLAN

SCALE 1:125M


 <p>Republic of the Philippines Department of Engineering City of Baguio Office: 1000 Baguio City Phone: (092) 866-1234 Fax: (092) 866-1235 Email: eng@cityofbaguio.gov.ph</p>	PROJECT TITLE:	DATE:	SUBMITTED BY:	RECOMMENDED APPROVAL:	APPROVED BY:	SHEET CONTENT:	SHEET NO.
	<p>PROPOSED REHABILITATION OF ELECTRICAL SYSTEM AT JUDGE FELICIANO BELMONTE SR. HIGH SCHOOL</p> <p>LOCATION: BANGAL, HOLY SPIRIT, DISTRICT 2, BAGUIO CITY</p>	<p>DESIGNED BY: YOM</p> <p>DRAWN BY: YOM</p> <p>CHECKED BY: YOM</p> <p>REVISION NO:</p>	<p>ENGR. FREDERICKA D. DE GUZMAN</p> <p>HEAD, PLANNING & DESIGN DIVISION</p>	<p>ENGR. ROBERT L. BELTRAN</p> <p>CH. DEPARTMENT OF ENGINEERING</p>	<p>HON. MA. JOSEFINA G. BELMONTE</p> <p>CITY MAYOR</p>	<p>POWER LAYOUT SB-1 BUILDING 2ND AND 4TH FLOOR PLAN</p>	<p>EL-17 23 37</p>

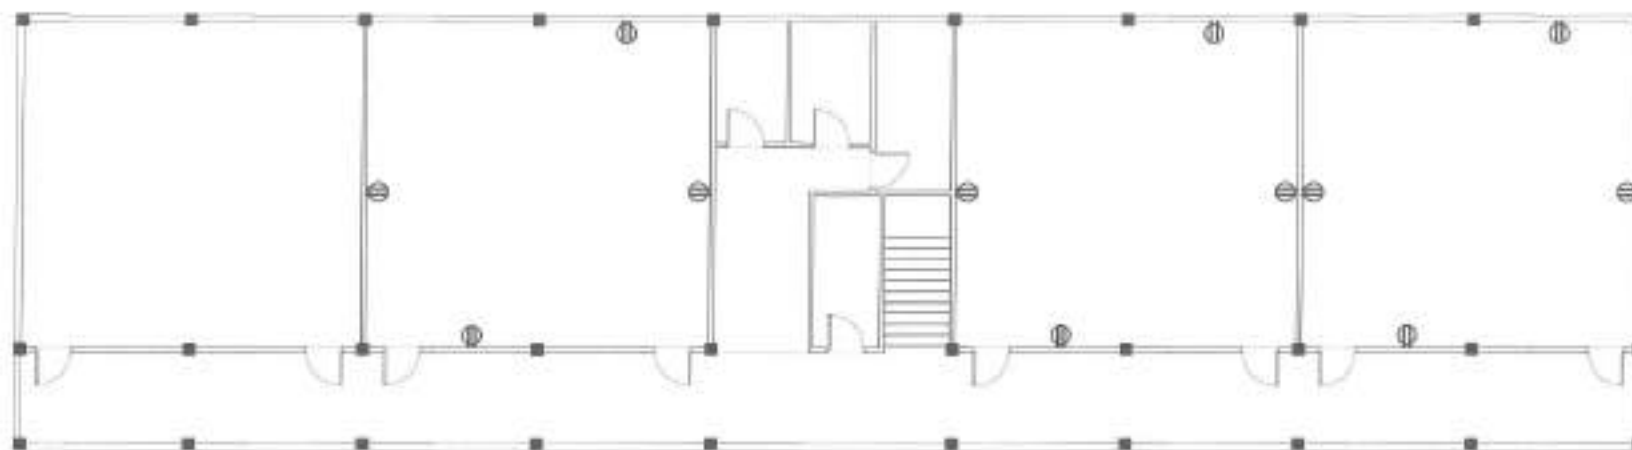

NOTE: REPLACEMENT OF CONVENIENCE OUTLET

1 POWER LAYOUT PAGCOR BUILDING GROUND FLOOR PLAN

SCALE 1:125M

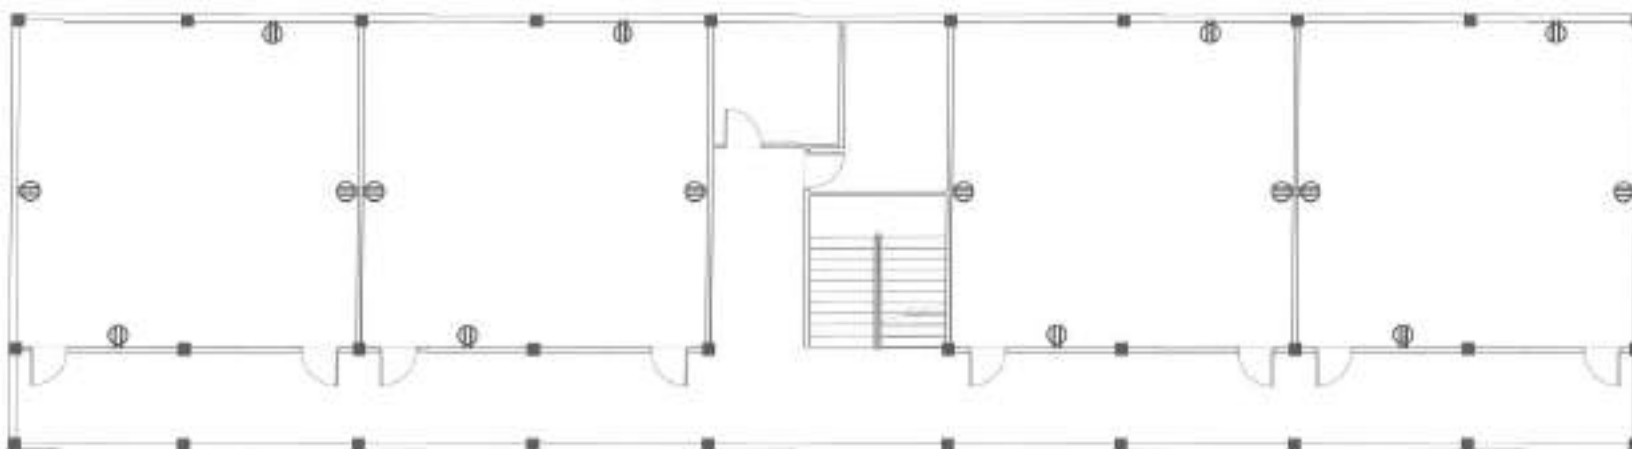

NOTE: REPLACEMENT OF CONVENIENCE OUTLET

2 POWER LAYOUT PAGCOR BUILDING 2ND TO 4TH FLOOR PLAN

SCALE 1:125M



Republic of the Philippines
Department of Engineering
1000 N. 10th St., 10th Floor
Manila, 1000
Tel: (02) 526-1000
Fax: (02) 526-1000

PROJECT TITLE:
**PROPOSED REHABILITATION OF
ELECTRICAL SYSTEM AT JUDGE
FELICIANO BELMONTE SR. HIGH
SCHOOL**

LOCATION:
BPOC, HOLY SPIRIT, DISTRICT 2, GUSZON CITY

DATE:
DESIGNED BY: *[Signature]*
DRAWN BY: *[Signature]*
CHECKED BY: *[Signature]*

PERMISSION NO.:

QUANTIFIED BY:
[Signature]
ENGR. FREDERICKA D. DE GUZMAN
NCE, PLUMBING & GAS DIVISION

RECOMMENDING APPROVAL:
[Signature]
ENGR. ROBERT E. BELTRAN
DEPARTMENT OF ENGINEERING

APPROVED BY:
[Signature]
HON. MA. JOSEFINA G. BELMONTE
CITY ANCHOR

SHEET CONTENT:
POWER LAYOUT
PAGCOR BUILDING
GROUND FLOOR
PLAN
POWER LAYOUT
PAGCOR BUILDING
2ND TO 4TH FLOOR
PLAN

SHEET NO.
**EL-18
24 37**

1	POWER LAYOUT DEPED B BUILDING GROUND FLOOR PLAN
---	---



PROJECT TITLE:	PROPOSED REHABILITATION OF ELECTRICAL SYSTEM AT JUDGE FELICIANO BELMONTE SR. HIGH SCHOOL
LOCATION:	3907 HOLY SPIRIT, DISTRICT 7, GLEZON CITY

DATE:	
DESIGNED BY: RMM	DRAWN BY: VAS
	
CHECKED BY: TEN	
APPROVED BY:	

ENDORSEMENT OF: _____

ENDOR: FREDERICK D. DE GUZMAN
HEAD, PLANNING & DESIGN DIVISION

RECOMMENDING APPROVAL:




MR. ROBERT L. SOLTRAN
CC, DEPARTMENT OF SUPERVISION

APPROVED BY _____
HON. MA. JOSEFINA G. BELMONTÉ
GOVERNOR

POWER LAYOUT
DETAILED BUILDING
ORDERED FLOOR
PLAN

EL-19
25 37

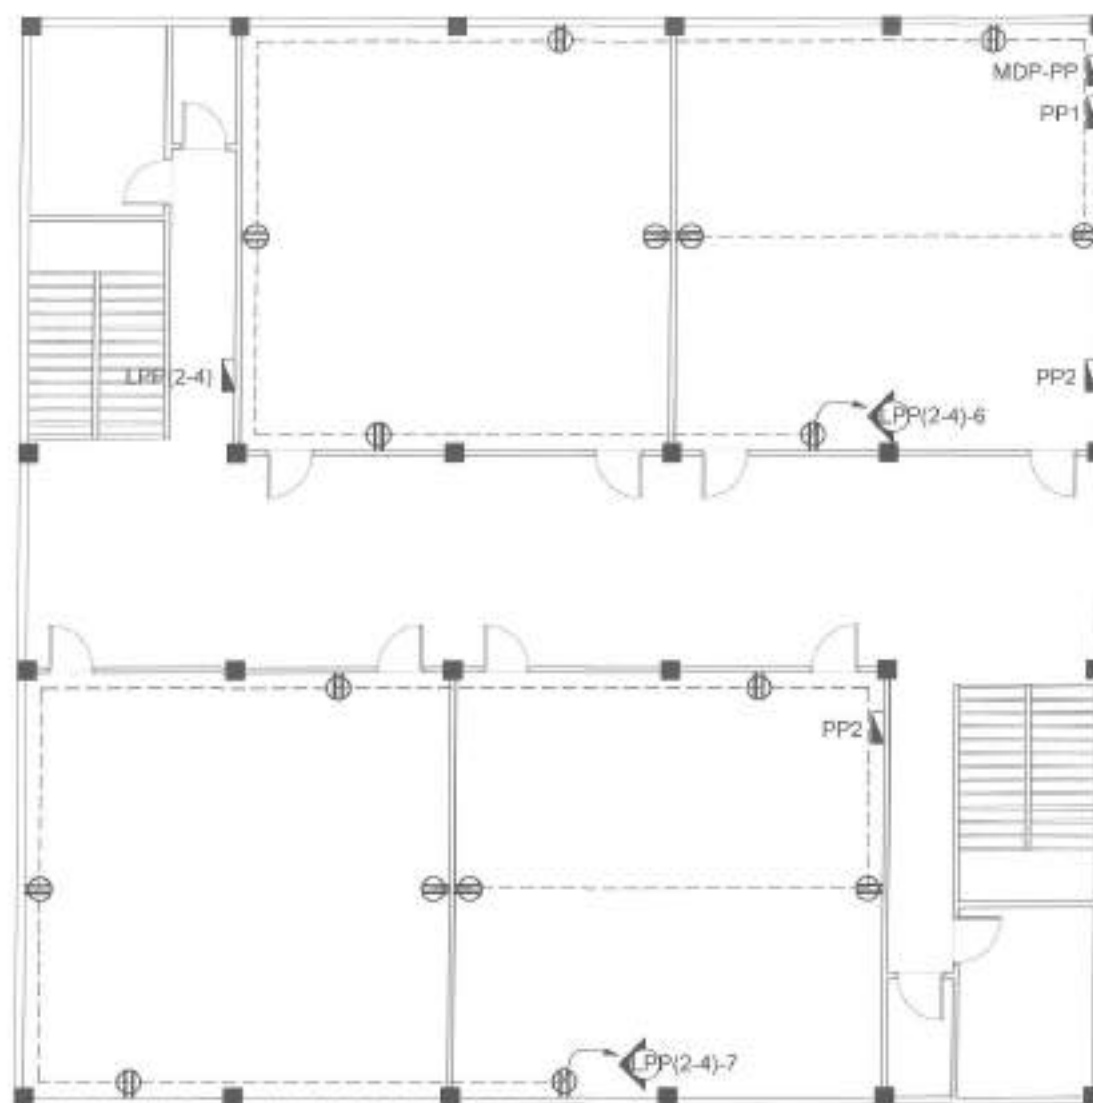

NOTE: REPLACEMENT OF PANEL BOARD, CONVENIENCE OUTLET AND RE-WIRING

1 POWER LAYOUT DEPED B BUILDING 2ND TO 4TH FLOOR PLAN

SCALE 1:100M



Republic of the Philippines
Department of Engineering
DepEd Division Office - Marikina
DepEd Marikina City
DepEd Marikina City
DepEd Marikina City

PROJECT TITLE
**PROPOSED REHABILITATION OF
ELECTRICAL SYSTEM AT JUDGE
FELICIANO BELMONTE SR. HIGH
SCHOOL**

LOCATION
BRGY. HOLY SPIRIT, DISTRICT 2, CAGZON CITY

DATE
DESIGNED BY: HMM
DRAWN BY: VML
CHECKED BY: RDM
REVISION NO.


SUBMITTED BY:
ENGR. FREDERICK D. DE GUZMAN
HEAD PLANNING & DESIGN DIVISION

RECOMMENDING APPROVAL:
ENGR. ROBERT L. BELTRAN
HEAD, DEPARTMENT OF ENGINEERING

APPROVED BY:
HON. MA. JOSEFINA G. BELMONTE
CITY MGR.

SHEET CONTENT
POWER LAYOUT
DEPED B BUILDING
2ND TO 4TH FLOOR
PLAN


SHEET NO.
EL-20
26 37

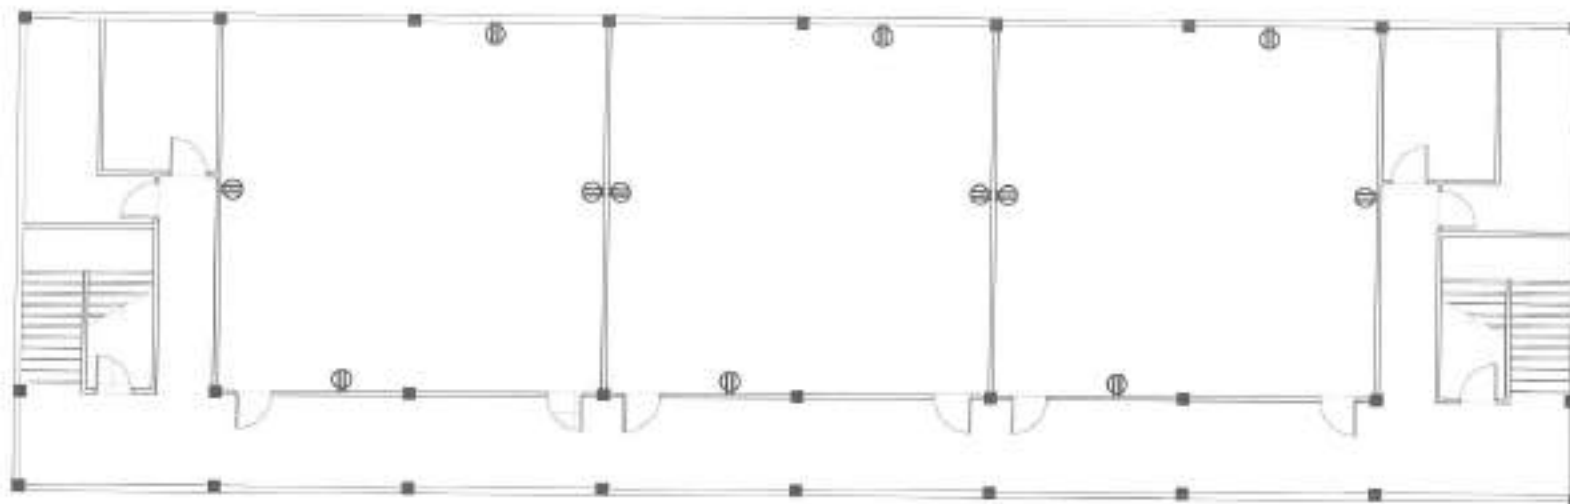

NOTE: REPLACEMENT OF CONVENIENCE OUTLET

1 POWER LAYOUT DEPED A BUILDING GROUND TO 3RD FLOOR PLAN

SCALE 1:125M

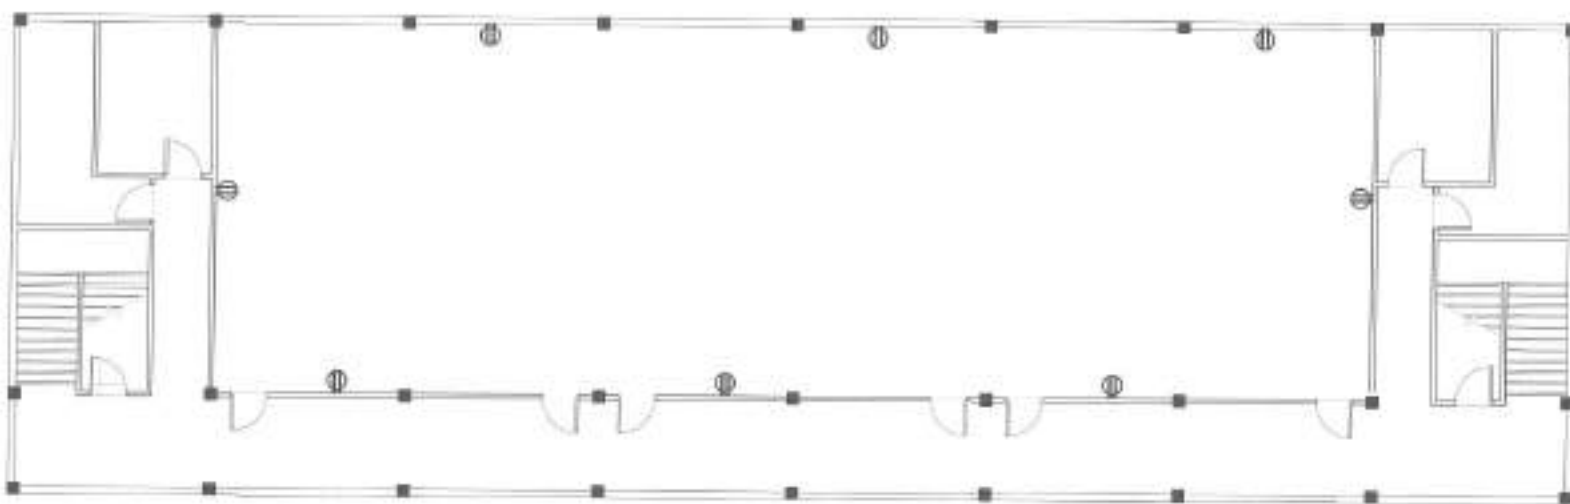

NOTE: REPLACEMENT OF CONVENIENCE OUTLET

2 POWER LAYOUT DEPED A BUILDING 4TH FLOOR PLAN

SCALE 1:125M



Republic of the Philippines
Department of Engineering
City Office, Technical Office, Engineering Office
Engineering Office, 1000 Avenue C
Quezon City, 1100 Quezon City
Telephone: (02) 2599-6382
Fax: (02) 2599-6382

PROJECT TITLE:
**PROPOSED REHABILITATION OF
ELECTRICAL SYSTEM AT JUDGE
FELICIANO BELMONTE SR. HIGH
SCHOOL**

LOCATION:
BRGY. KELLY SPRAY, DISTRICT 2, QUEZON CITY

DATE:

DESIGNED BY: SAG

DRAWN BY: SAG

CHECKED BY: SAG

PROVISION NO.:

SUBMITTED BY:

ENGR. FREDERICKA CL. DE GUZMAN
HEAD, PLANNING & DESIGN DIVISION

RECOMMENDING APPROVAL:

ENGR. ROBERT L. BELTRAN
DEPARTMENT OF ENGINEERING

APPROVED BY:


HON. MA. JOSEFINA G. BELMONTE
CITY MAYOR

SHEET CONTENT:

POWER LAYOUT
DEPED A BUILDING
GROUND TO 3RD
FLOOR PLAN
POWER LAYOUT
DEPED A BUILDING
4TH FLOOR PLAN

SHEET NO.:


EL-21
27 37

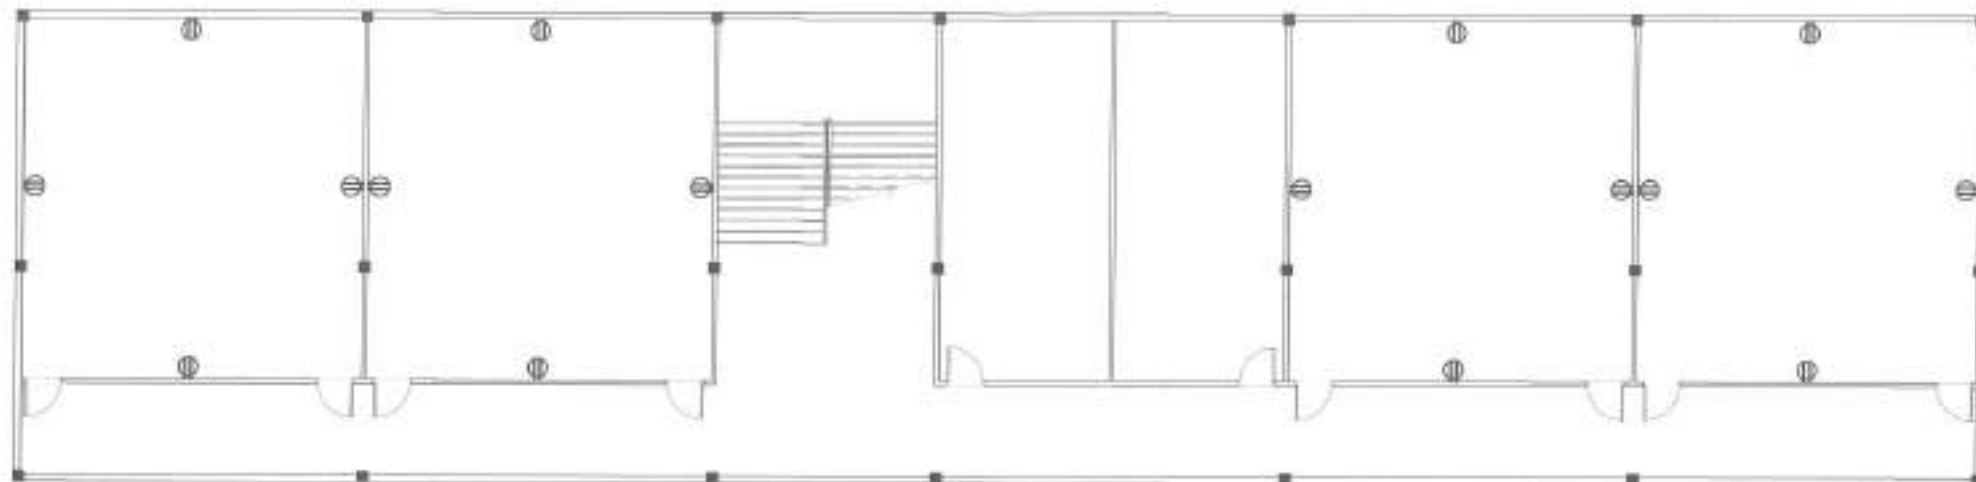

NOTE: REPLACEMENT OF CONVENIENCE OUTLET

1 POWER LAYOUT SB-2 BUILDING GROUND AND 3RD FLOOR PLAN

SCALE 1:125M

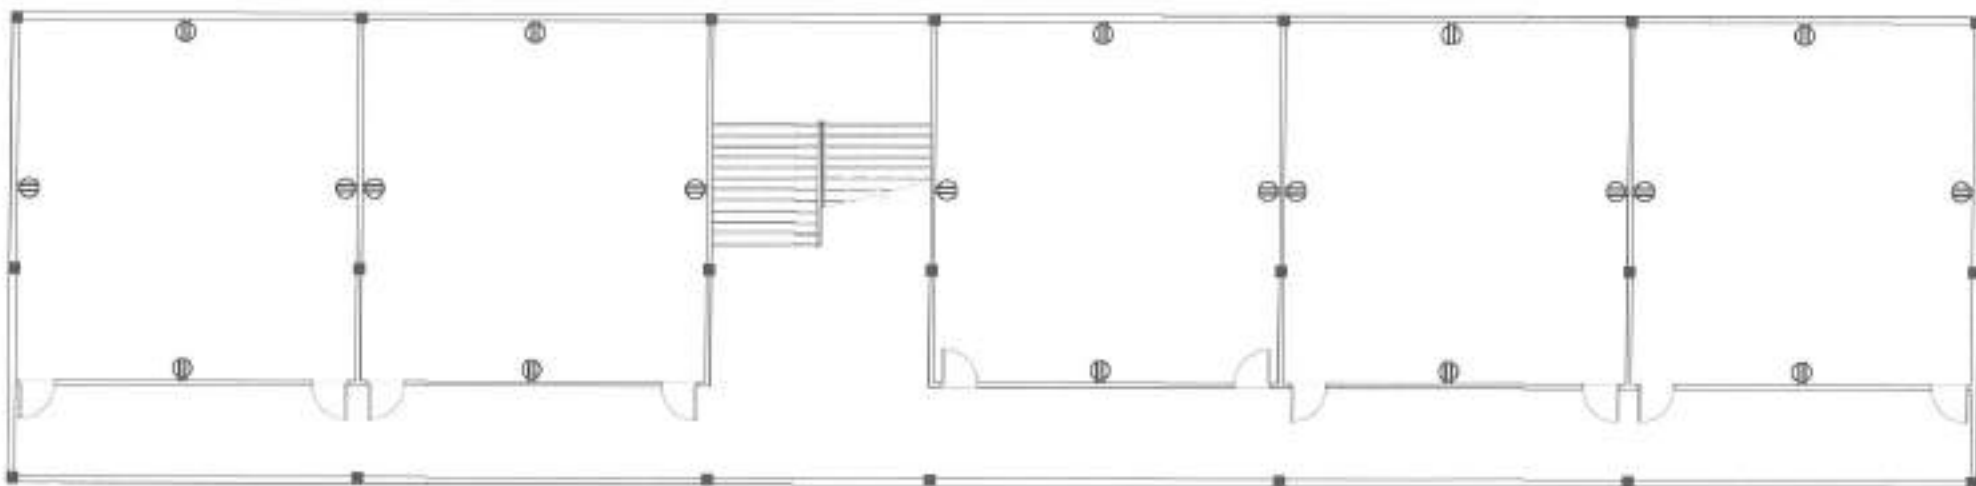

NOTE: REPLACEMENT OF CONVENIENCE OUTLET

2 POWER LAYOUT SB-2 BUILDING 2ND AND 4TH FLOOR PLAN

SCALE 1:125M



Republic of the Philippines
 Department of Engineering
 1000 South Building 10, 10th Floor, 10th Floor
 (Manila, Luzon) 1000 South Building 10, 10th Floor
 (Manila, Luzon) 1000 South Building 10, 10th Floor

PROJECT TITLE:
**PROPOSED REHABILITATION OF
 ELECTRICAL SYSTEM AT JUDGE
 FELICIANO BELMONTE SR. HIGH
 SCHOOL**

LOCATION:
 BRGY. ROCK SPRING, DISTRICT 3, QUEZON CITY

DATE:
 DESIGNED BY: *AMM*
 DRAWN BY: *YSC*
 CHECKED BY: *NSM*

REVISOR NO.:


SUBMITTED BY:
ENGR. FREDERICKA D.L. DE GUZMAN
 ROAD PLANNING & DESIGN DIVISION

RECOMMENDING AGENCY:
ENGR. ROBERT L. BELTRAN
 CIVIL DEPARTMENT OF ENGINEERING

APPROVED BY:
HON. MA. JOSEFINA G. BELMONTE
 CITY MAJOR

SHEET CONTENT:
 POWER LAYOUT SB-2
 BUILDING GROUND
 AND 3RD FLOOR
 PLAN
 POWER LAYOUT SB-2
 BUILDING 2ND AND
 4TH FLOOR PLAN


SHEET NO.
**EL-22
 28 37**

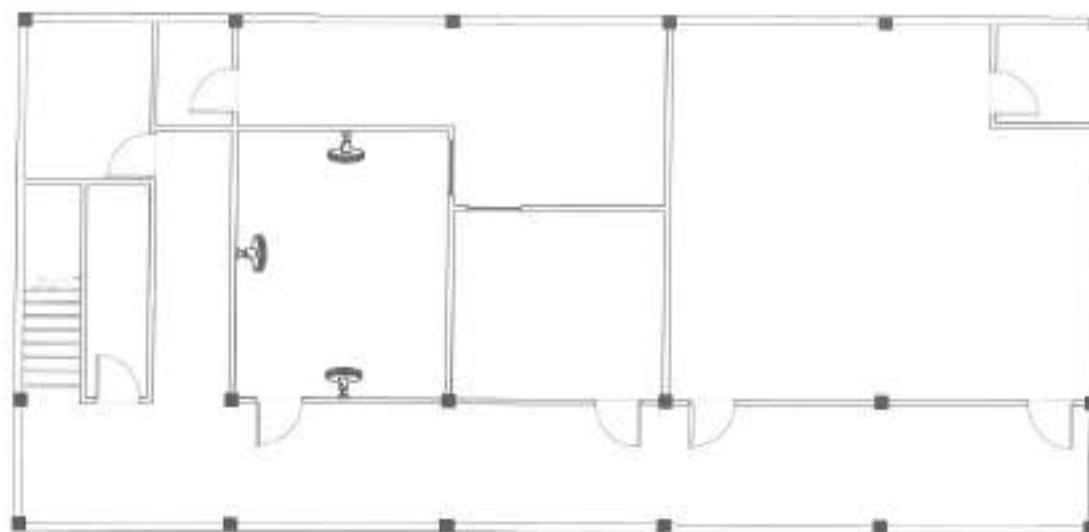

NOTE: REPLACEMENT OF WALL FAN
PROVIDE ONE-GANG OUTLET EACH WALL FAN

1 WALL FAN LAYOUT DEPED C BUILDING GROUND FLOOR PLAN

SCALE 1:100M

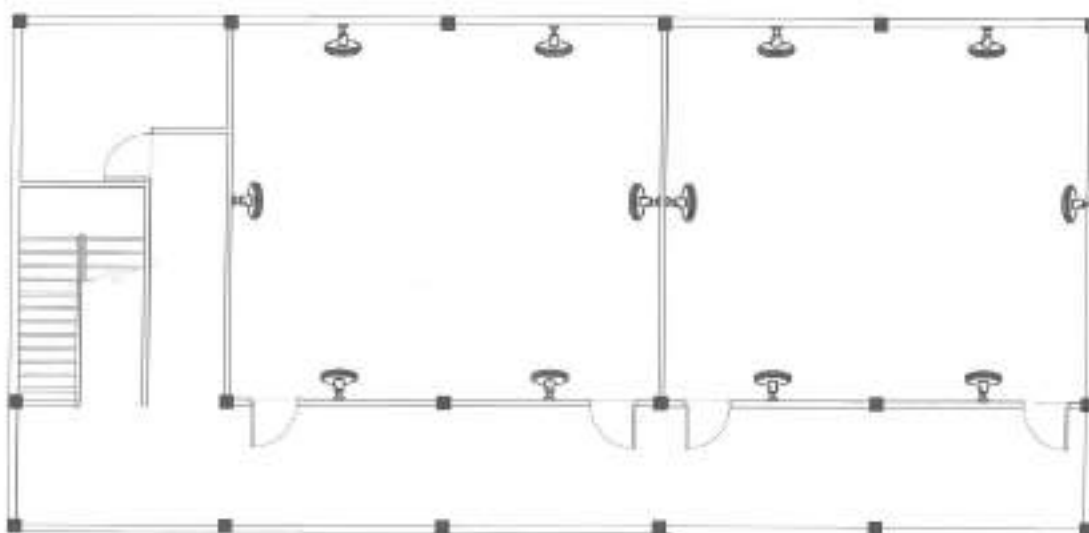

NOTE: REPLACEMENT OF WALL FAN
PROVIDE ONE-GANG OUTLET EACH WALL FAN

2 WALL FAN LAYOUT DEPED C BUILDING 2ND TO 4TH FLOOR PLAN

SCALE 1:100M



Republic of the Philippines
Department of Engineering
2nd Floor, Room 201, 10th Floor, Room 201
Cebu, Cebu City, Cebu 6000
Tel: (033) 338-1111, 338-1112
Email: depeng@deped.gov.ph

PROJECT TITLE:
**PROPOSED REHABILITATION OF
ELECTRICAL SYSTEM AT JUDGE
FELICIANO BELMONTE SR. HIGH
SCHOOL**

LOCATION:
BPOV, HOLY SPIRIT, DISTRICT 3, GUZMAN CITY

DATE:

DESIGNED BY: RMR
[Signature]

DRAWN BY: RMY
[Signature]
CHECKED BY: RMR

REVISION NO.:

SUBMITTED BY:

[Signature]
ENGR. FREDERICKA OL. DE GUZMAN
PEEL PLANNING & DESIGN DIVISION

RECOMMENDING APPROVAL:

[Signature]
ENGR. ROBERT L. BELTRAN
CEO, DEPARTMENT OF ENGINEERING

APPROVED BY:


[Signature]
HON. MA. JOSEFINA O. BELMONTE
CITY MAYOR

SHEET CONTENT:

WALL FAN LAYOUT
DEPED C BUILDING
GROUND FLOOR
PLAN
WALL FAN LAYOUT
DEPED C BUILDING
2ND TO 4TH FLOOR
PLAN

SHEET NO.:


EL-23
29/37

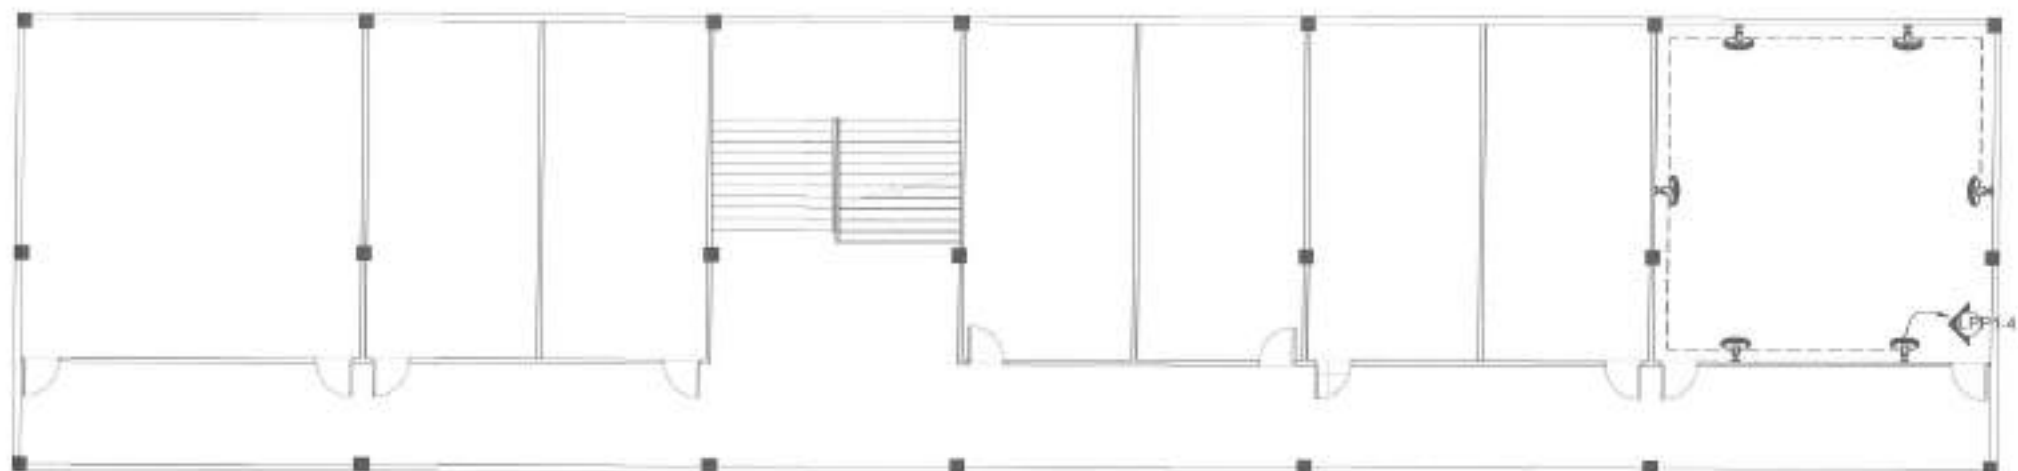

NOTE: REPLACEMENT OF WALL FAN AND RE-WIRING
PROVIDE ONE-GANG OUTLET EACH WALL FAN

1 WALL FAN LAYOUT SB-1 BUILDING GROUND FLOOR PLAN

SCALE: 1/125M

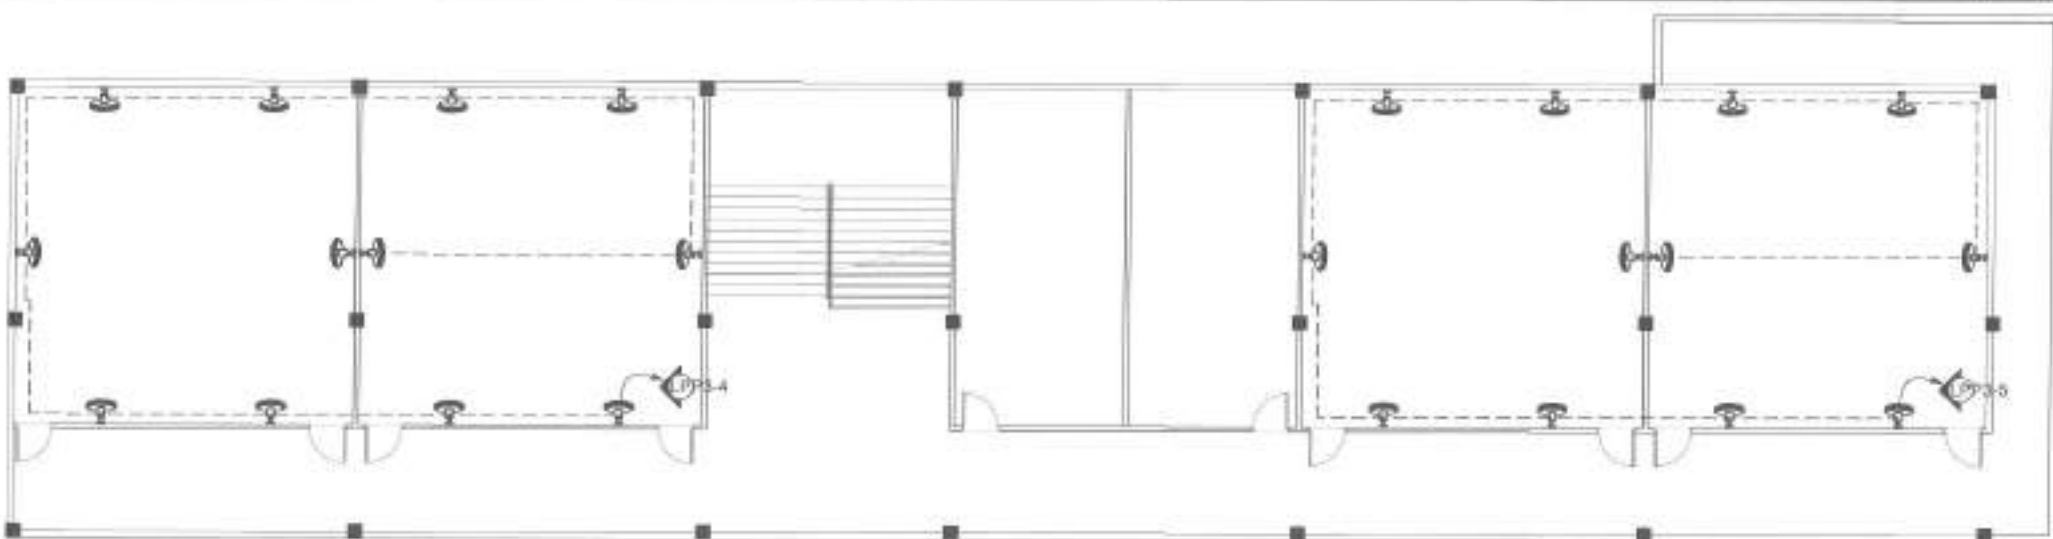


NOTE: REPLACEMENT OF PANEL BOARD CONVENIENCE OUTLET AND RE-WIRING
PROVIDE ONE-GANG OUTLET EACH WALL FAN

2 WALL FAN LAYOUT SB-1 BUILDING 3RD FLOOR PLAN

SCALE: 1/125M

 <p>Republic of the Philippines Department of Engineering 2nd Floor, 10th Avenue, Quezon City 1100 Quezon City Telephone: 411 1000, 411 1001 Email: deo@deop.gov.ph</p>	PROJECT TITLE:	DATE:	SUBMITTED BY:	RECOMMENDING APPROVAL:	APPROVED BY:	SHEET CONTENT:	SHEET NO.:
	<p>PROPOSED REHABILITATION OF ELECTRICAL SYSTEM AT JUDGE FELICIANO BELMONTE SR. HIGH SCHOOL</p> <p>LOCATION: BRGY. HOLY SPIRIT, DISTRICT 3, QUEZON CITY</p>	<p>DESIGNED BY: JMM</p> <p>CHIEF ENGINEER: JMM</p> <p>REVISOR: JMM</p>	<p>ENGR. FREDERICK D. DE GUZMAN</p> <p>HEAD, PLANNING & DESIGN DIVISION</p>	<p>ENGR. ROBERT L. BELTRAN</p> <p>CHIEF, DEPARTMENT OF ENGINEERING</p>	<p>HON. MA. JOSEFINA G. BELMONTE</p> <p>CITY MAYOR</p>	<p>WALL FAN LAYOUT 3RD FLOOR PLUS WALL FAN LAYOUT SB-1 GROUND FLOOR FLOOR PLAN</p>	<p>EL-24 30/37</p>

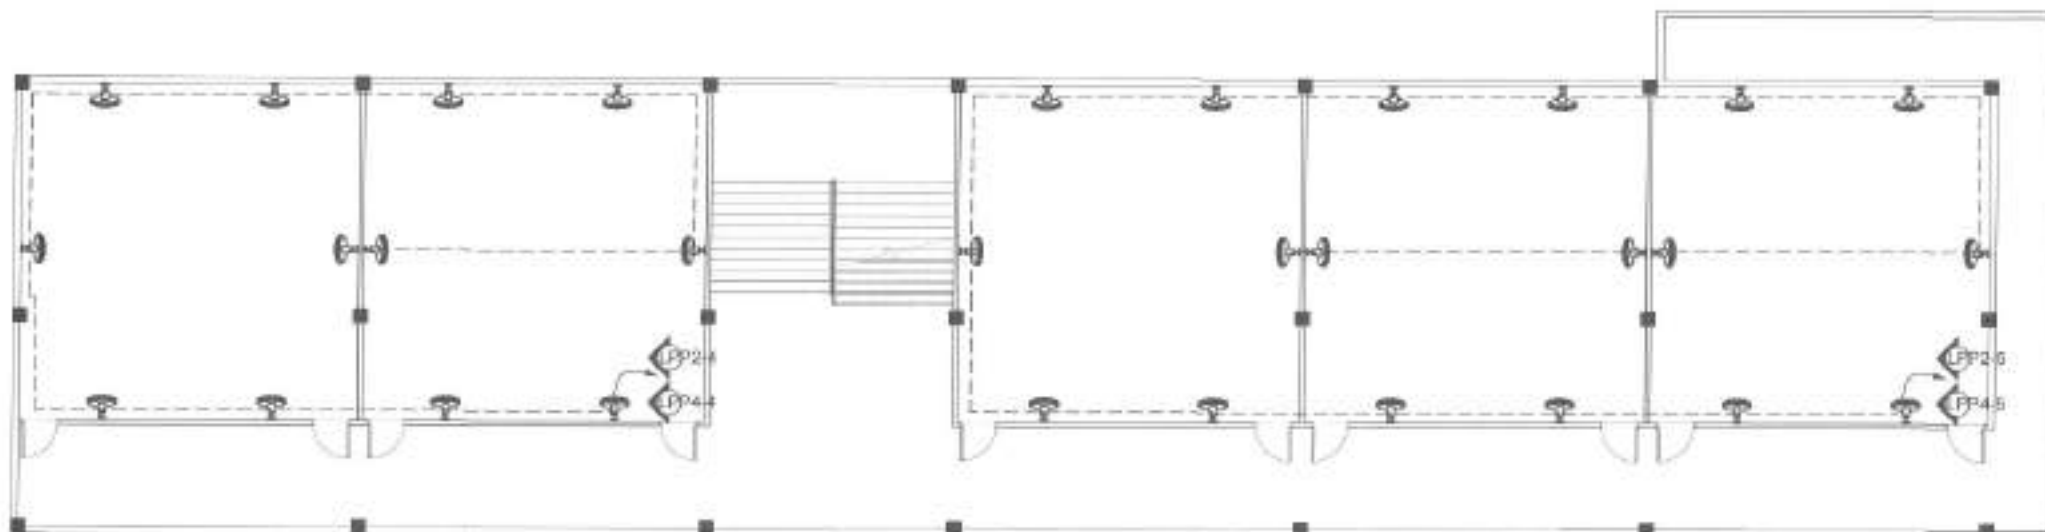


NOTE: REPLACEMENT OF WALL FAN AND RE-WIRING
 PROVIDE ONE-GANG OUTLET EACH WALL FAN

1 WALL FAN LAYOUT SB-1 BUILDING 2ND AND 4TH FLOOR PLAN

SCALE 1:125M

 <p>Regulation ng Paggawa Department of Engineering City of Quezon City Division Office - 1102 Quezon City Telephone: (02) 8666-4000 Email: deo@quezoncity.gov.ph</p>	PROJECT TITLE:	DATE:	SUBMITTED BY:	RECOMMENDED APPROVAL:	APPROVED BY:	SHEET CONTENT:	SHEET NO.
	PROPOSED REHABILITATION OF ELECTRICAL SYSTEM AT JUDGE FELICIANO BELMONTE SR. HIGH SCHOOL	DESIGNED BY: RMM  DRAWN BY: YAM  CHECKED BY: RRM 	ENGR. FREDSWICK D. DE GUZMAN REG. ELECTRICAL ENGINEER	ENGR. ROBERT L. BELTRAN REG. ELECTRICAL ENGINEER	HON. MA. JOSEFINA G. BELMONTE CITY MAYOR	WALL FAN LAYOUT SB-1 BUILDING 2ND AND 4TH FLOOR PLAN	EL-25 31 37
	LOCATION: BRGY. HOLY SPIRIT, DISTRICT 2, QUEZON CITY	REVISION NO.:					

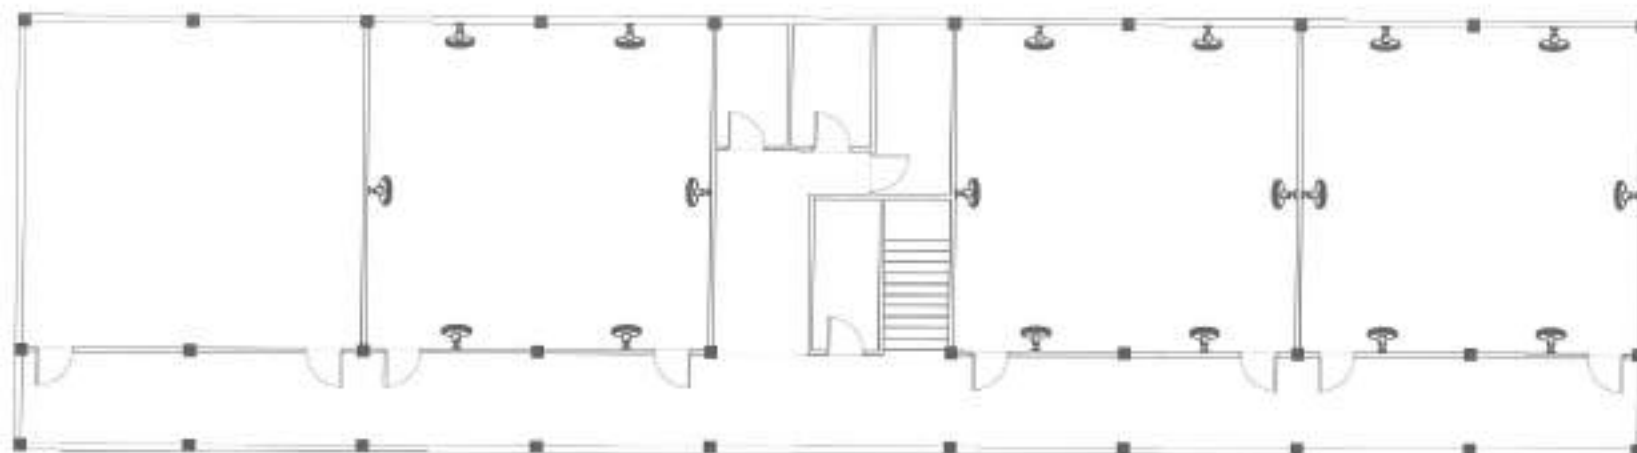

NOTE: REPLACEMENT OF WALL FAN
PROVIDE ONE-GANG OUTLET EACH WALL FAN

1 WALL FAN LAYOUT PAGCOR BUILDING GROUND FLOOR PLAN

SCALE 1:125M




NOTE: REPLACEMENT OF WALL FAN
PROVIDE ONE-GANG OUTLET EACH WALL FAN

2 WALL FAN LAYOUT PAGCOR BUILDING 2ND TO 4TH FLOOR PLAN

SCALE 1:125M

 <p>Republic of the Philippines Department of Engineering 200 Green Road, 2nd Floor, 2nd Floor, 2nd Floor Manila, Philippines 1000 Tel: (632) 594-4343 E-mail: depeng@depeng.gov.ph</p>	PROJECT TITLE	DATE	SUBMITTED BY	PROPOSED ENGINEER APPROVAL	APPROVED BY	SHEET CONTENT	SHEET NO.
	PROPOSED REHABILITATION OF ELECTRICAL SYSTEM AT JUDGE FELICIANO BELMONTE SR. HIGH SCHOOL LOCATION: BRGY. HOLY SPIRIT, DISTRICT 2, QUEZON CITY	DESIGNED BY: <i>[Signature]</i> CHECKED BY: <i>[Signature]</i> DRAWN BY: <i>[Signature]</i>	ENGR. FREDERICK DE GUZMAN HEAD PLANNING & DESIGN DIVISION	ENGR. ROBERT L. BELTRAN DEPARTMENT OF ENGINEERING	HON. MA. JOSEFINA G. BELMONTE CITY MAYOR	WALL FAN LAYOUT PAGCOR BUILDING 2ND TO 4TH FLOOR PLAN	EL-26 32 37

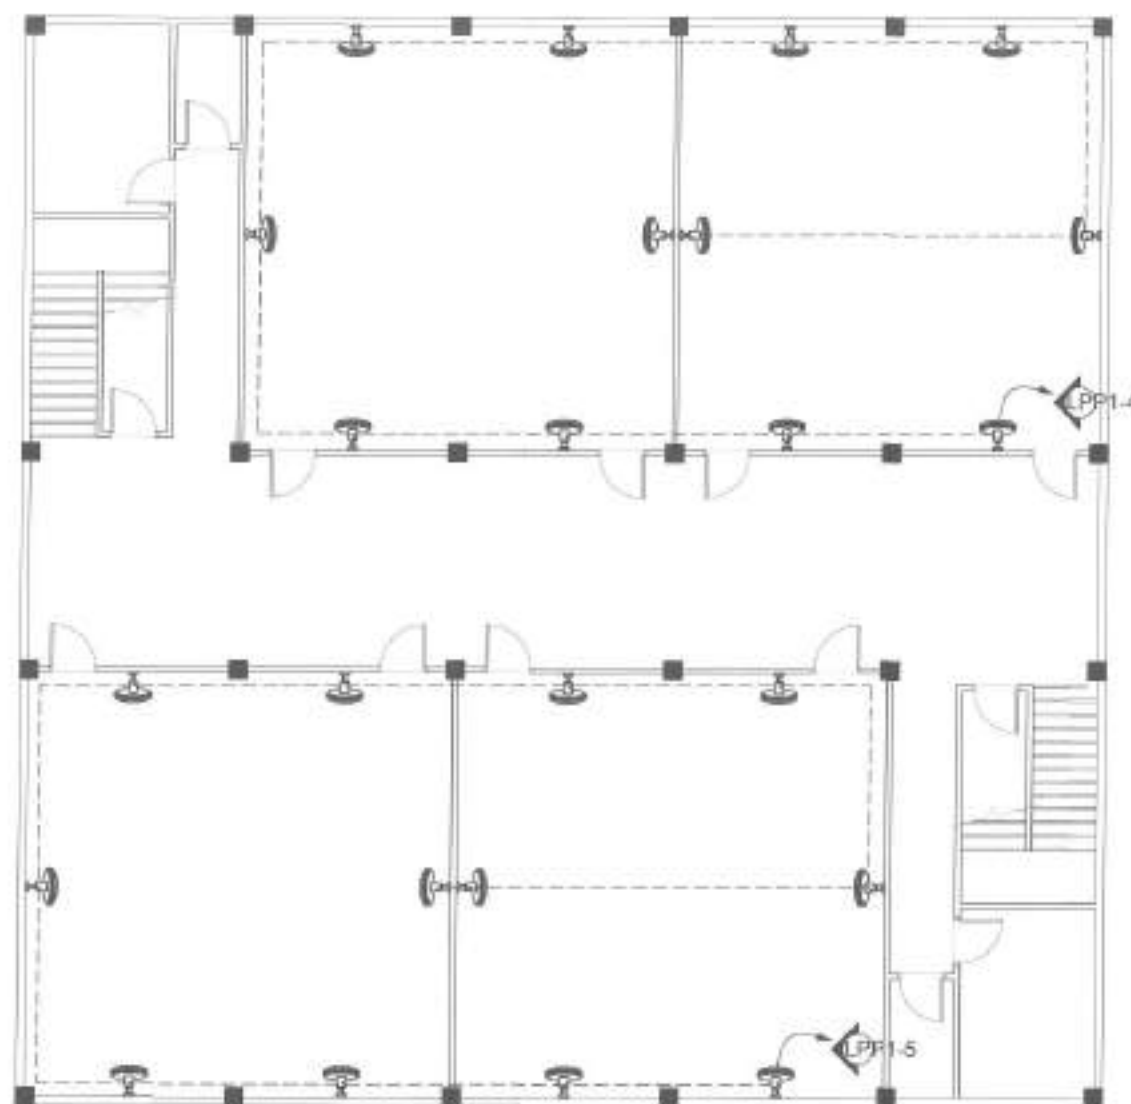


NOTE: REPLACEMENT OF WALL FAN AND RE-WIRING
PROVIDE ONE-GANG OUTLET EACH WALL FAN

1 WALL FAN LAYOUT DEPED B BUILDING GROUND FLOOR PLAN

SCALE: 1:100M

 <p>Republika ng Pilipinas Lungsod ng Quezon DEPARTMENT OF ENGINEERING San Carlos Avenue & City Hall Compound, Quezon Road Quezon City 1105 Philippines Tel: (02) 7799-4394 E-mail: deo@quezoncity.gov.ph</p>	<p>PROJECT TITLE:</p> <p>PROPOSED REHABILITATION OF ELECTRICAL SYSTEM AT JUDGE FELICIANO BELMONTE SR. HIGH SCHOOL</p> <p>LOCATION:</p> <p>BRGY. HOLY SPIRIT, DISTRICT 2, QUEZON CITY</p>	<p>DATE:</p> <p>DESIGNED BY: <i>WAM</i></p> <p>DRAWN BY: <i>WAM</i></p> <p>CHECKED BY: <i>WAM</i></p> <p>REVISION NO.:</p>	<p>SUBMITTED BY:</p> <p>ENGR. FREDY VICTOR L. DE GUZMAN HEAD, PLANNING & DESIGN DIVISION</p>	<p>RECOMMENDING AGENCY:</p> <p>ENGR. ROBERT L. BELTRAN CITY DEPARTMENT OF ENGINEERING</p>	<p>APPROVED BY:</p> <p>HON. MA. JOSEFINA G. BELMONTE CITY MAYOR</p>	<p>SHEET CONTENT:</p> <p>WALL FAN LAYOUT DEPED B BUILDING GROUND FLOOR PLAN</p>	<p>SHEET NO.</p> <p>EL-27 33 37</p>
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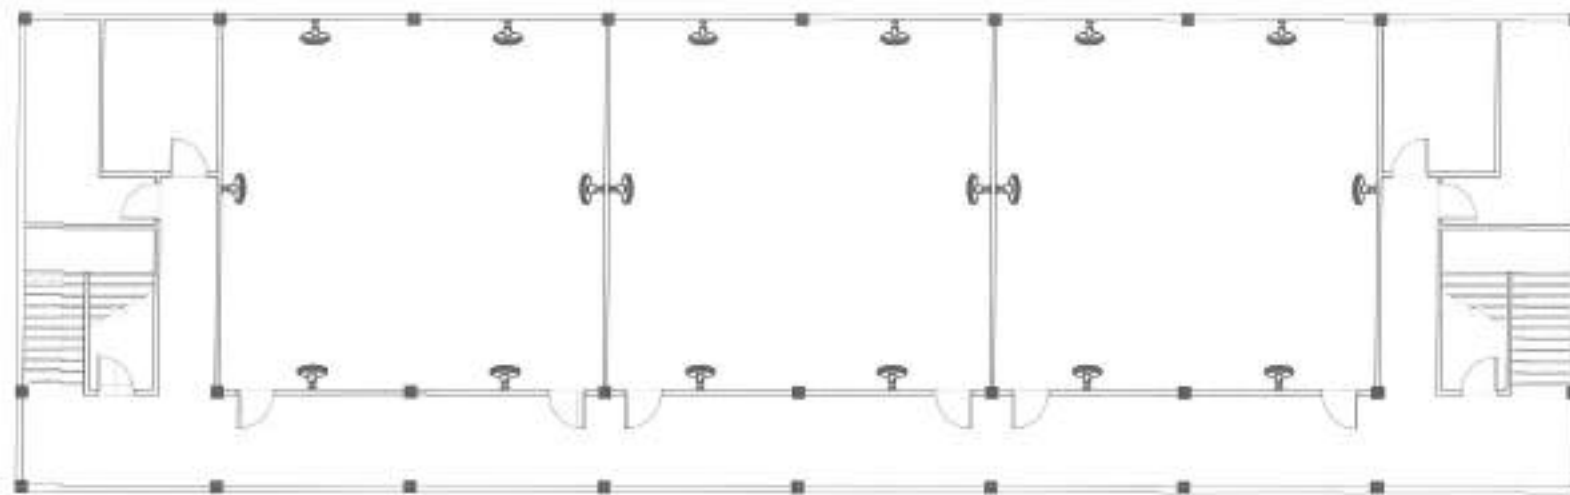


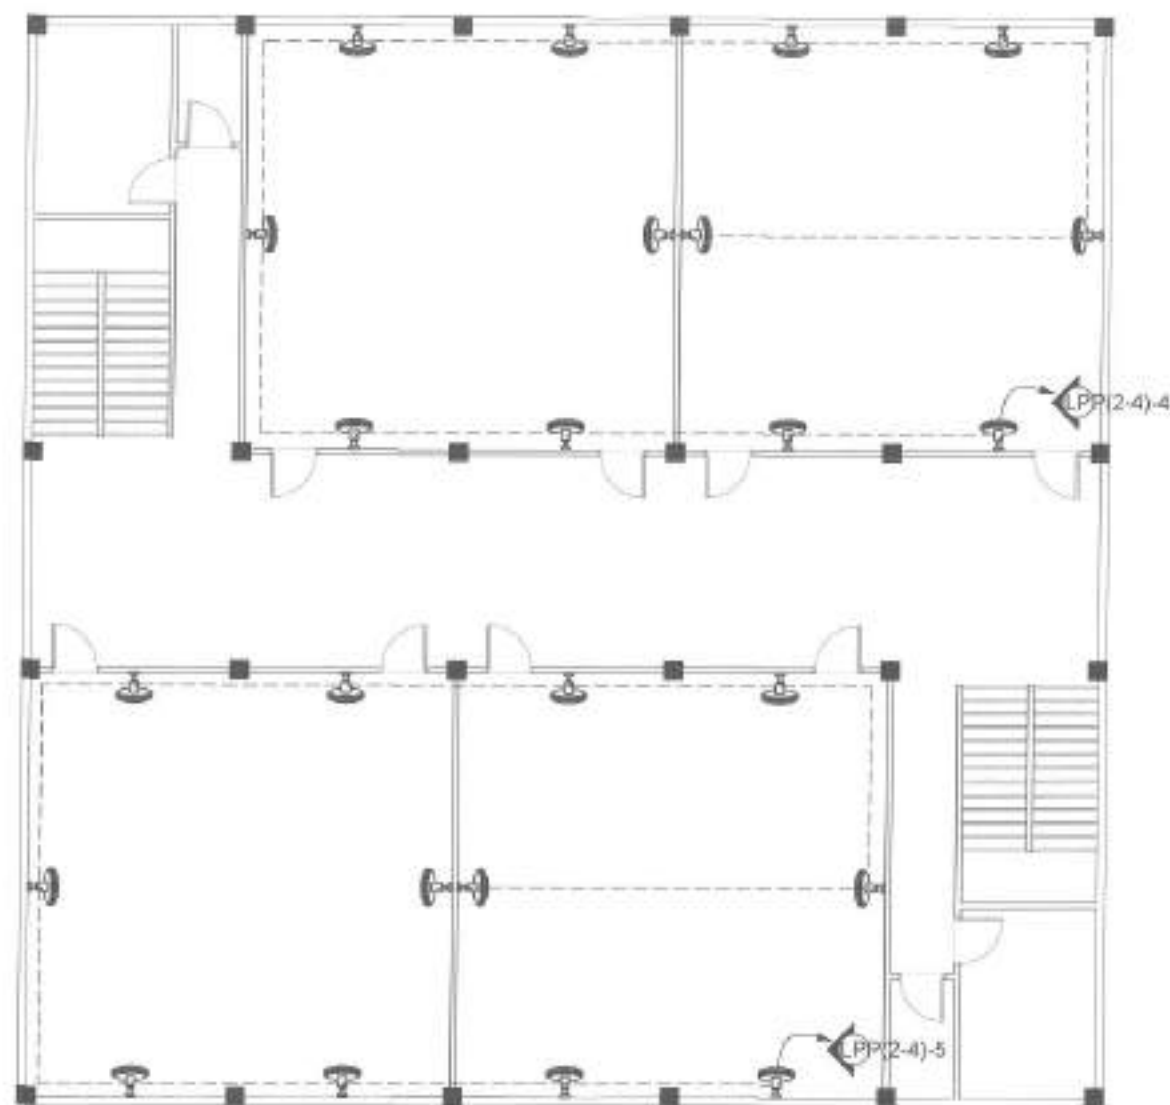NOTE: REPLACEMENT OF WALL FAN AND RE-WIRING
PROVIDE ONE-GANG OUTLET EACH WALL FAN

1 WALL FAN LAYOUT DEPED B BUILDING 2ND TO 4TH FLOOR PLAN

SCALE 1:100A


 <p>Isipnila ng Pilipinas Lagingat ng Usapin DEPARTMENT OF ENGINEERING One City Square, One City Square, Manila 1000, Manila 1000 (City) Tel: (02) 5261-1000 E: deped@deped.gov.ph</p>	PROJECT TITLE	DATE	SUBMITTED BY	RECOMMENDED APPROVAL	APPROVED BY	REVIEW COMMENTS	SHEET NO.
	PROPOSED REHABILITATION OF ELECTRICAL SYSTEM AT JUDGE FELICIANO BELMONTE SR. HIGH SCHOOL	DESIGNED BY: AMM  CHECKED BY: VEV  DESIGNED BY: RON 	ENGR. FREDSWINIA D. DE GUZMAN (HOLD PLUMBING & ELECTRICAL LICENSE)	 ENGR. ROBERT L. BELMONT (HOLD PLUMBING & ELECTRICAL LICENSE)	HON. NA. JOSEFINA G. BELMONTE CITY MAYOR 	WALL FAN LAYOUT DEPED B BUILDING 2ND TO 4TH FLOOR PLAN	EL-28 34 / 37
LOCATION: BRGY. HOLY SPIRIT, DISTRICT 1, QUEZON CITY	REVISION NO.:						



NOTE: REPLACEMENT OF WALL FAN
PROVIDE ONE-GANG OUTLET EACH WALL FAN

1 WALL FAN LAYOUT DEPED A BUILDING GROUND TO 3RD FLOOR PLAN

SCALE 1:125M

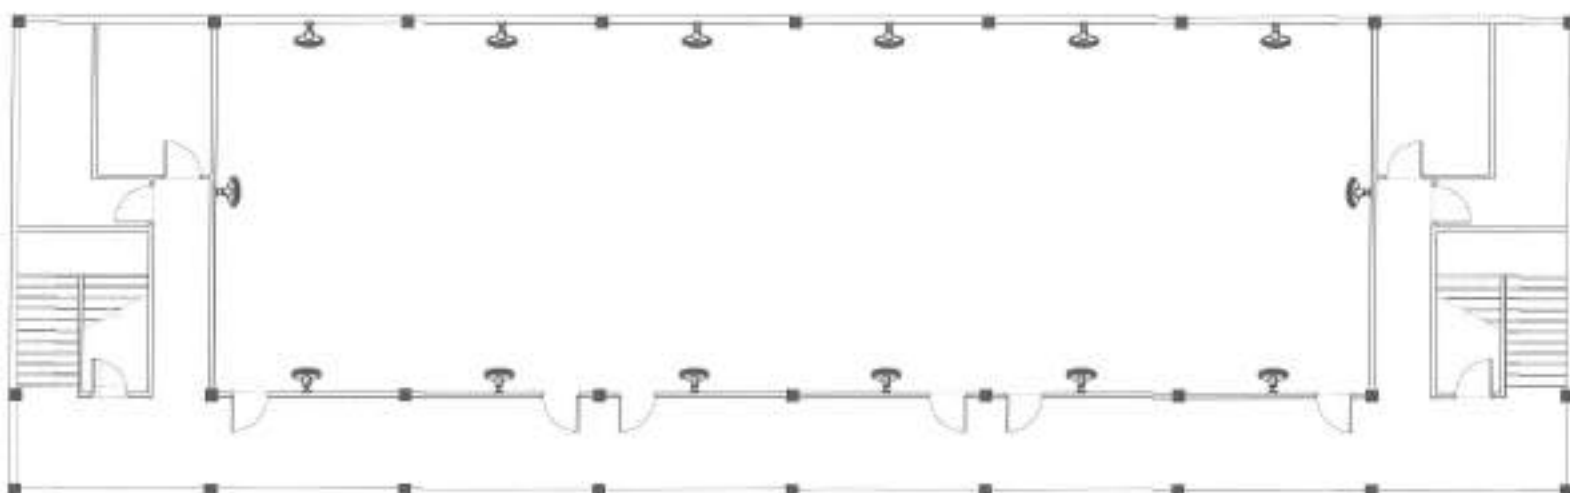

NOTE: REPLACEMENT OF WALL FAN
PROVIDE ONE-GANG OUTLET EACH WALL FAN

2 WALL FAN LAYOUT DEPED A BUILDING 4TH FLOOR PLAN

SCALE 1:125M



Republic of the Philippines
Department of Engineering
1000 Green Building City Hall Complex, 1000 Green Building
1000 Green Building, 1000 Green Building
1000 Green Building, 1000 Green Building
1000 Green Building, 1000 Green Building

PROJECT TITLE
**PROPOSED REHABILITATION OF
ELECTRICAL SYSTEM AT JUDGE
FELICIANO BELMONTE SR. HIGH
SCHOOL**

LOCATION
BRGY. HOLY SPIRIT, DISTRICT 5, QUEZON CITY

DATE

DESIGNED BY: JRM

Checked by: JRM

Drawn by: JRM

SUBMITTER

ENGR. FREDERICK D. DE GUZMAN
HEAD, PLANNING & DESIGN DIVISION

RECOMMENDING OFFICIAL

ENGR. ROBERT L. BELTRAN
DC, DEPARTMENT OF ENGINEERING

APPROVED BY


HON. MA. JOSEFINA G. BELMONTE
CITY ASST.

SHEET CONTENT

WALL FAN LAYOUT
DEPED A BUILDING
GROUND TO 3RD
FLOOR PLAN
WALL FAN LAYOUT
DEPED A BUILDING
4TH FLOOR PLAN

SHEET NO.


EL-29
35/37

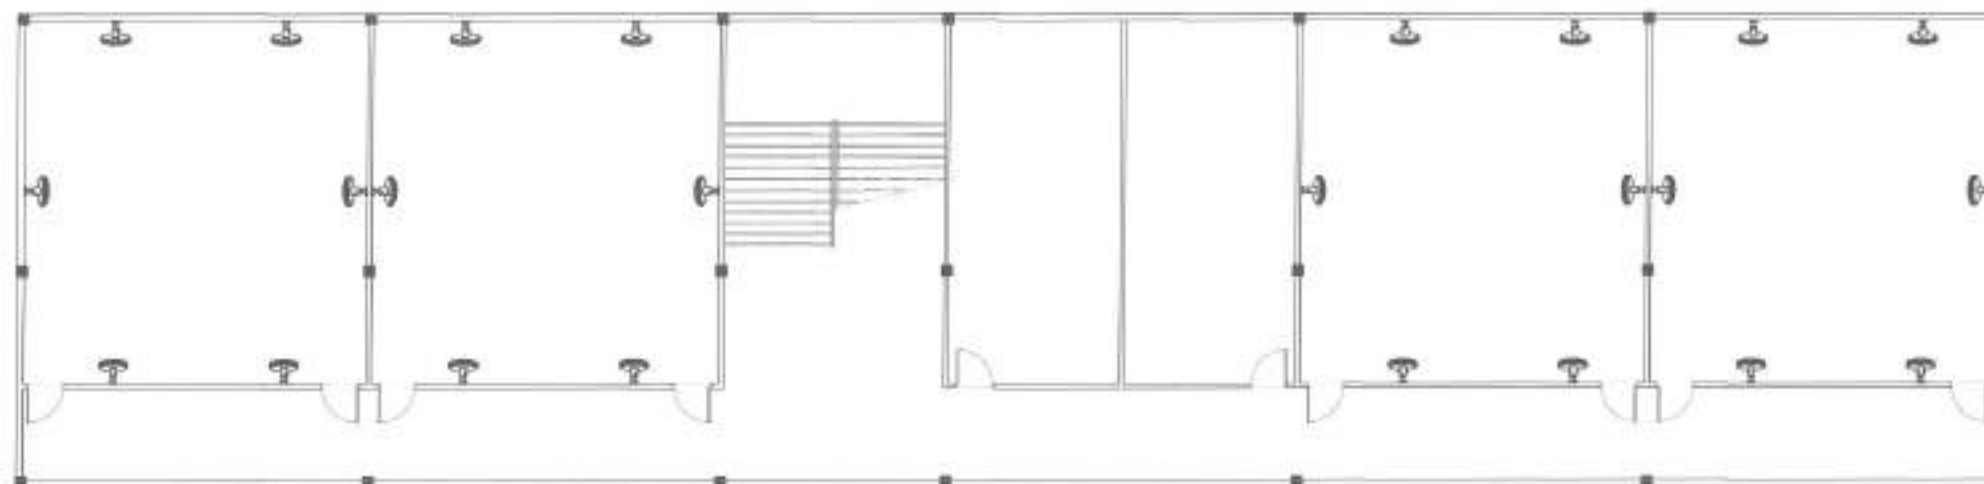

NOTE: REPLACEMENT OF WALL FAN
PROVIDE ONE-GANG OUTLET EACH WALL FAN

1 WALL FAN LAYOUT SB-2 BUILDING GROUND AND 3RD FLOOR PLAN

SCALE 1:125M

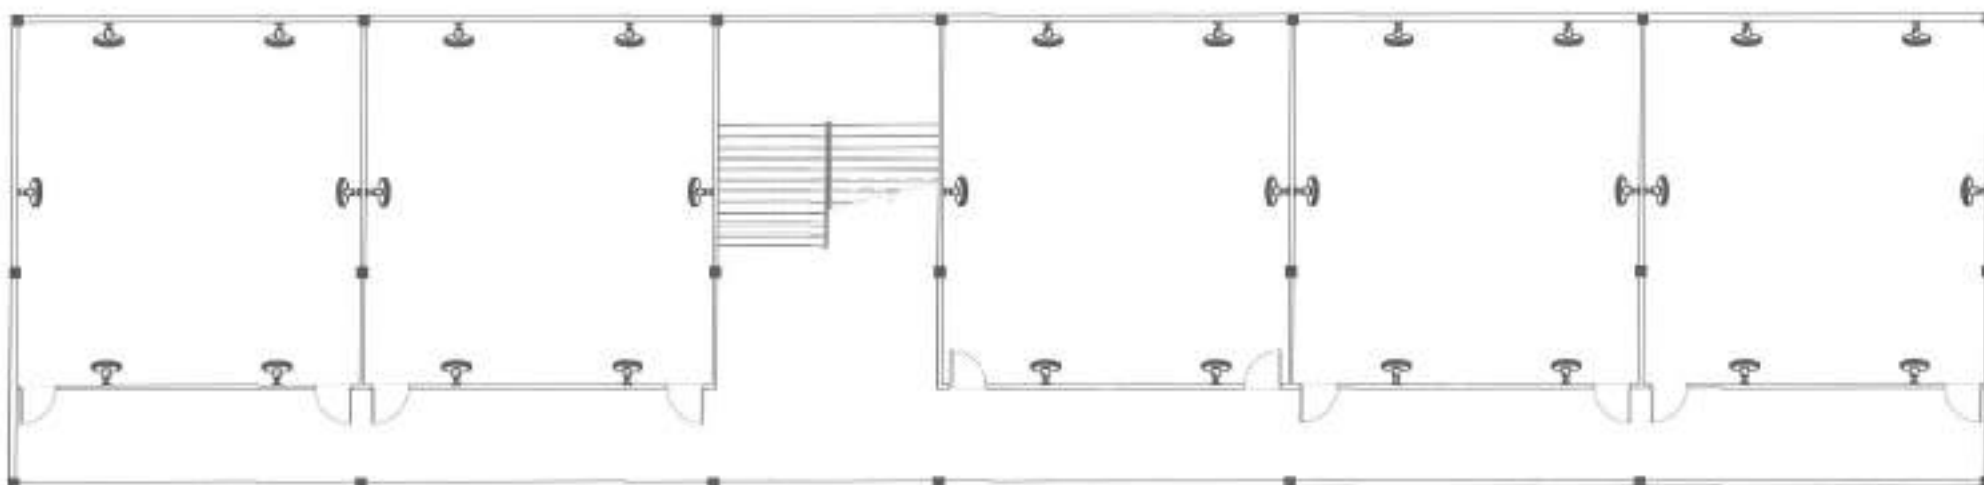


NOTE: REPLACEMENT OF WALL FAN
PROVIDE ONE-GANG OUTLET EACH WALL FAN

2 WALL FAN LAYOUT SB-2 BUILDING 2ND AND 4TH FLOOR PLAN

SCALE 1:125M

 <p>Republic of the Philippines Department of Engineering City of Quezon City Office of the City Engineer City of Quezon City E-mail: ceo@quezoncity.gov.ph</p>	PROJECT TITLE:	DATE:	DESIGNED BY: KAM	DRAWN BY: VAE	CHECKED BY: REN	REVISION NO.:	PROJECT NO. BY:	RECOMMENDING APPROVAL:	APPROVED BY:	SHEET CONTENT:	SHEET NO.:
	<p>PROPOSED REHABILITATION OF ELECTRICAL SYSTEM AT JUDGE FELICIANO BELMONTE SR. HIGH SCHOOL</p> <p>LOCATION: BRGY. NOLY SPRING, DISTRICT 2, QUEZON CITY</p>	<p>ENGR. FREDERICK D. DE GUZMAN HEAD, PLANNING & DESIGN DIVISION</p>	<p>ENGR. ROBERT L. BELTRAN CHIEF, DEPARTMENT OF ENGINEERING</p>	<p>HON. MA. JOSEFINA G. BELMONTE CITY MAYOR</p>	<p>WALL FAN LAYOUT 2ND BUILDING GROUND AND 3RD FLOOR PLAN WALL FAN LAYOUT 2ND BUILDING 2ND AND 4TH FLOOR PLAN</p>	<p>EL-30 36/37</p>					

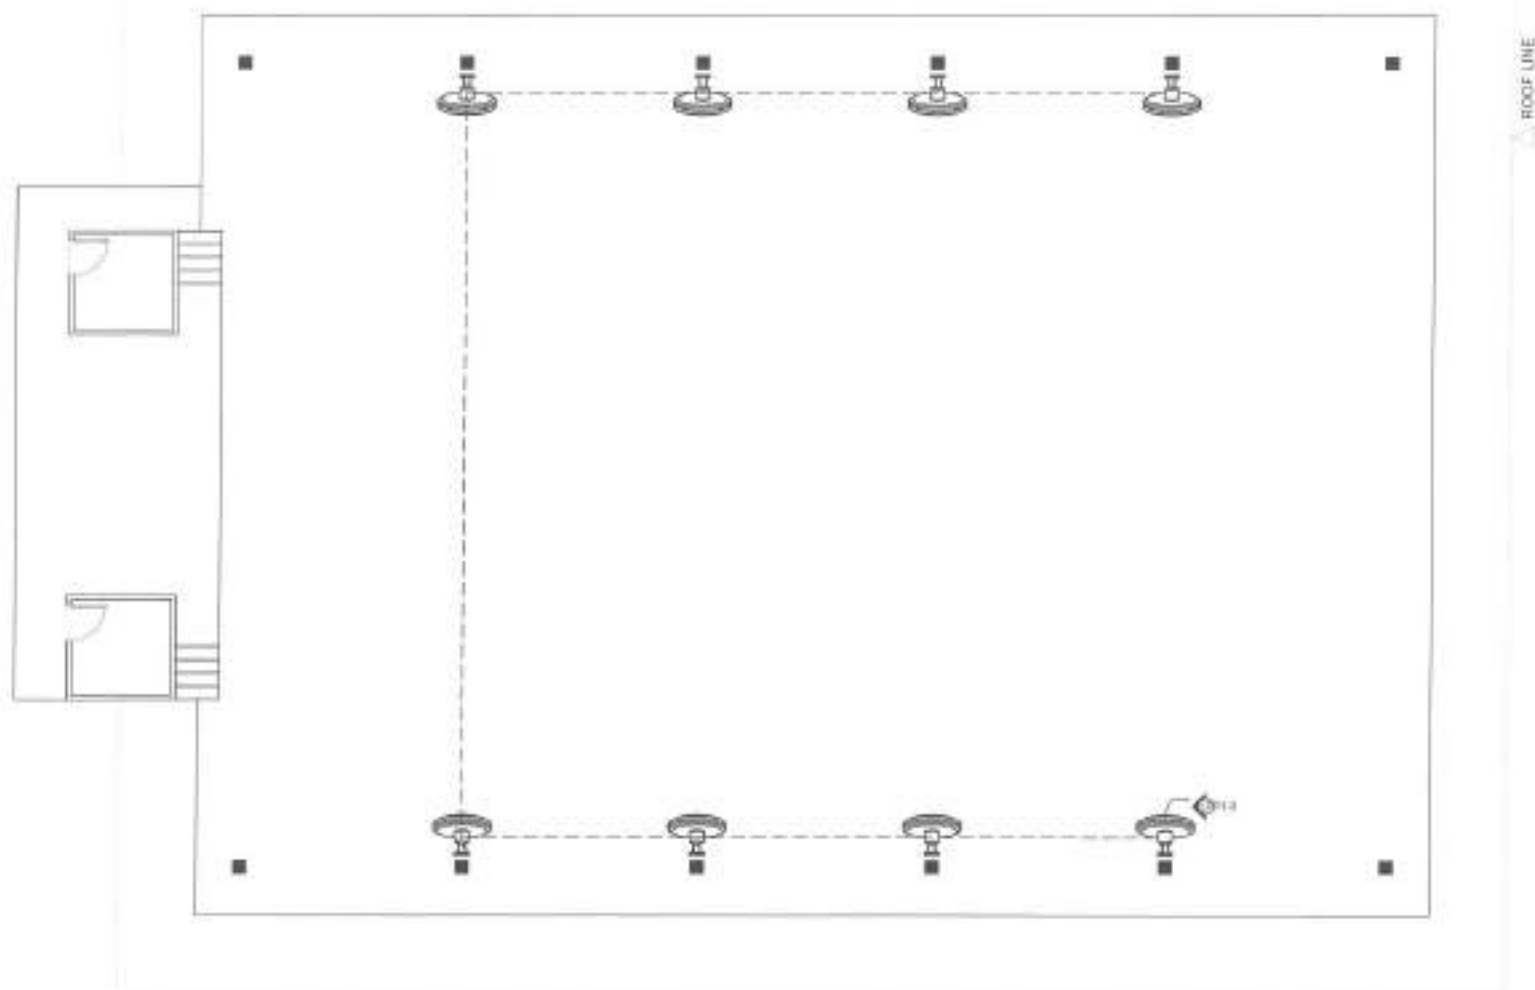

NOTE: ADDITIONAL INDUSTRIAL WALL FAN AND WIRING

1 WALL FAN LAYOUT COVERED COURT

SCALE 1:125M

 <p>Quezon City Engineer Engineering Office DEPARTMENT OF ENGINEERING Quezon City Building 5, City Hall Compound, Quezon City Quezon City, Philippines 1100 Telephone: (02) 8696 8000 Fax: (02) 8696 8001</p>	PROJECT TITLE:	DATE:	DESIGNED BY:	RECOMMENDING APPROVAL:	APPROVED BY:	SHEET CONTENT:	SHEET NO.
	PROPOSED REHABILITATION OF ELECTRICAL SYSTEM AT JUDGE FELICIANO BELMONTE SR. HIGH SCHOOL	DESIGNED BY: RMG  CHECKED BY: RMG 	SUBMITTED BY: 	RECOMMENDING APPROVAL: 	APPROVED BY: 	WALL FAN LAYOUT COVERED COURT	EL-31 37 37
LOCATION: BRGY. HOLY SPIRIT, DISTRICT 2, QUEZON CITY	REVISION NO.:	ENGR. FREDERICK M. DE GUZMAN HEAD, PLANNING & DESIGN DIVISION	ENGR. ROBERT L. BELTRAN DCL, DEPARTMENT OF ENGINEERING	HON. MA. JOSEFINA G. BELMONTE CITY MARCH			

Section VIII. Bill of Quantities

Notes on the Bill of Quantities

Objectives

The objectives of the Bill of Quantities are:

- a. to provide sufficient information on the quantities of Works to be performed to enable Bids to be prepared efficiently and accurately; and
- b. when a Contract has been entered into, to provide a priced Bill of Quantities for use in the periodic valuation of Works executed.

In order to attain these objectives, Works should be itemized in the Bill of Quantities in sufficient detail to distinguish between the different classes of Works, or between Works of the same nature carried out in different locations or in other circumstances which may give rise to different considerations of cost. Consistent with these requirements, the layout and content of the Bill of Quantities should be as simple and brief as possible.

Daywork Schedule

A Daywork Schedule should be included only if the probability of unforeseen work, outside the items included in the Bill of Quantities, is high. To facilitate checking by the Entity of the realism of rates quoted by the Bidders, the Daywork Schedule should normally comprise the following:

- a. A list of the various classes of labor, materials, and Constructional Plant for which basic daywork rates or prices are to be inserted by the Bidder, together with a statement of the conditions under which the Contractor will be paid for work executed on a daywork basis.
- b. Nominal quantities for each item of Daywork, to be priced by each Bidder at Daywork rates as Bid. The rate to be entered by the Bidder against each basic Daywork item should include the Contractor's profit, overheads, supervision, and other charges.

Provisional Sums

A general provision for physical contingencies (quantity overruns) may be made by including a provisional sum in the Summary Bill of Quantities. Similarly, a contingency allowance for possible price increases should be provided as a provisional sum in the Summary Bill of Quantities. The inclusion of such provisional sums often facilitates budgetary approval by avoiding the need to request periodic supplementary approvals as the future need arises. Where such provisional sums or contingency allowances are used, the SCC should state the manner in which they will be used, and under whose authority (usually the Procuring Entity's Representative's).

The estimated cost of specialized work to be carried out, or of special goods to be supplied, by other contractors should be indicated in the relevant part of the Bill of Quantities as a particular provisional sum with an appropriate brief description. A separate procurement procedure is normally carried out by the Procuring Entity to select such specialized contractors. To provide an element of competition among the Bidders in respect of any facilities, amenities, attendance, etc., to be provided by the successful Bidder as prime Contractor for the use and convenience of the specialist contractors, each related provisional sum should be followed by an item in the Bill of Quantities inviting the Bidder to quote a sum for such amenities, facilities, attendance, etc.

Signature Box

A signature box shall be added at the bottom of each page of the Bill of Quantities where the authorized representative of the Bidder shall affix his signature. Failure of the authorized representative to sign each and every page of the Bill of Quantities shall be a cause for rejection of his bid.

These Notes for Preparing a Bill of Quantities are intended only as information for the Procuring Entity or the person drafting the Bidding Documents. They should not be included in the final documents.

PROJECT TITLE : PROPOSED REHABILITATION OF ELECTRICAL SYSTEM AT JUDGE FELICIANO BELMONTE SR. HIGH SCHOOL

LOCATION : BARANGAY HOLY SPIRIT, DISTRICT 2, QUEZON CITY

PROJECT NO. : 23 - 00196

DURATION : One Hundred Fifty (150) Calendar Days

BREAKDOWN OF COST

ITEM NO.	DESCRIPTION	ESTIMATED DIRECT COST	TOTAL MARK-UP		VAT	TOTAL INDIRECT COST	TOTAL COST
			%	VALUE			
PART I	OTHER GENERAL REQUIREMENTS						
PART II	CIVIL, SANITARY/PLUMBING, AND ELECTRICAL WORKS						
PART A	REMOVAL WORKS						
PART B	FINISHING AND OTHER CIVIL WORKS						
PART C	ELECTRICAL WORKS						
TOTAL							

TOTAL COST ₱ _____

LUMP SUM BID IN WORDS : _____

Contractor : _____

BILL OF QUANTITIES
(Building Construction/Rehabilitation Project)

PROJECT TITLE : PROPOSED REHABILITATION OF ELECTRICAL SYSTEM AT JUDGE FELICIANO BELMONTE SR. HIGH SCHOOL

LOCATION : BARANGAY HOLY SPIRIT, DISTRICT 2, QUEZON CITY

PROJECT NO. : 23 - 00196

DURATION : One Hundred Fifty (150) Calendar Days

ITEM CODE	DESCRIPTION	QUANTITY	UNIT	ESTIMATED DIRECT COST	MARK-UP IN %		TOTAL MARK-UP		VAT	TOTAL INDIRECT COST	TOTAL COST	UNIT COST
					OCM	PROFIT	%	VALUE				
PART I	OTHER GENERAL REQUIREMENTS											
B.5	Project Billboard / Sign Board	1	ea									
B.7(1)	Occupational Safety and Health	5	mo									
	TOTAL OF PART I											
PART II	CIVIL, SANITARY/PLUMBING, AND ELECTRICAL WORKS											
PART A	REMOVAL WORKS											
801(1)	Removal of Actual Structures / Obstruction (Ceiling and Roofing)	1	l.s									
801(6)	Chipping Works	1	cu.m									
	TOTAL OF PART A											
PART B	FINISHING AND OTHER CIVIL WORKS											
B.1 Masonry Works												
1027(1)	Cement Plaster Finish	14	sq.m									
B.2 Carpentry and Joinery												
1003(1)a1	Ceiling, 4.5mm, Metal Frame, Fiber Cement Board	2,838	sq.m									
B.3 Painting Works												
1032(1)a	Painting Works, Masonry/Concrete	14	sq.m									
1032(1)b	Painting Works, Wood	2,838	sq.m									

ITEM CODE	DESCRIPTION	QUANTITY	UNIT	ESTIMATED DIRECT COST	MARK-UP IN %		TOTAL MARK-UP		VAT	TOTAL INDIRECT COST	TOTAL COST	UNIT COST
					OCM	PROFIT	%	VALUE				
B.4 Roofing Works												
1014(1)b	Prepainted Metal Sheets, above 0427mm, Rib Type, Long Span, Ga.24	691	sq.m									
1013(2)a1	Fabricated Metal Roofing Accessory, Gauge 26, Ridge/Hip Rolls	77	l.m.									
	TOTAL OF PART B											
PART C	ELECTRICAL WORKS											
1100(10)	Conduits, Boxes and Fittings (Conduit works/Conduit Rough-in)	1	l.s									
1101(33)	Wires and Wiring Devices	1	l.s									
1102(1)	Panelboard with Main and Branch Breakers	1	l.s									
1103(1)	Lighting Fixtures and Lamps	1	l.s									
	TOTAL OF PART C											
	TOTAL OF PART II											
	GRAND TOTAL											

Section IX. Checklist of Technical and Financial Documents

Notes on the Checklist of Technical and Financial Documents

The prescribed documents in the checklist are mandatory to be submitted in the Bid, but shall be subject to the following:

- a. GPPB Resolution No. 09-2020 on the efficient procurement measures during a State of Calamity or other similar issuances that shall allow the use of alternate documents in lieu of the mandated requirements; or
- b. any subsequent GPPB issuances adjusting the documentary requirements after the effectivity of the adoption of the PBDs.

The BAC shall be checking the submitted documents of each Bidder against this checklist to ascertain if they are all present, using a non-discretionary “pass/fail” criterion pursuant to Section 30 of the 2016 revised IRR of RA No. 9184.

Checklist of Technical and Financial Documents

I. TECHNICAL COMPONENT ENVELOPE

Class “A” Documents

Legal Documents

- ☐ (a) Valid PhilGEPS Registration Certificate (Platinum Membership) (all pages);
and
- ☐ (b) Registration certificate from Securities and Exchange Commission (SEC), Department of Trade and Industry (DTI) for sole proprietorship, or Cooperative Development Authority (CDA) for cooperatives or its equivalent document;
and
- ☐ (c) Mayor’s or Business permit issued by the city or municipality where the principal place of business of the prospective bidder is located, or the equivalent document for Exclusive Economic Zones or Areas;
and
- ☐ (e) Tax clearance per E.O. No. 398, s. 2005, as finally reviewed and approved by the Bureau of Internal Revenue (BIR).

Technical Documents

- ☐ (f) Statement of the prospective bidder of all its ongoing government and private contracts, including contracts awarded but not yet started, if any, whether similar or not similar in nature and complexity to the contract to be bid (*please see attached prescribed forms required by the QC – BAC for Infrastructure and Consultancy*); **and**
- ☐ (g) Statement of the bidder’s Single Largest Completed Contract (SLCC) similar to the contract to be bid, except under conditions provided under the rules with an attached Notice of Award, Notice to Proceed, Contract and Certificate of Acceptance (*please see attached prescribed form required by the QC – BAC for Infrastructure and Consultancy*); **and**
- ☐ (h) Philippine Contractors Accreditation Board (PCAB) License;
or
Special PCAB License in case of Joint Ventures;
and registration for the type and cost of the contract to be bid; **and**
- ☐ (i) Original copy of Bid Security. If in the form of a Surety Bond, submit also a certification issued by the Insurance Commission;
or
Original copy of Notarized Bid Securing Declaration; **and**
- ☐ (j) Project Requirements, which shall include the following:
 - ☐ a. Organizational chart for the contract to be bid;
 - ☐ b. List of contractor’s key personnel (*e.g.*, Project Manager, Project Engineers, Materials Engineers, and Foremen), to be assigned to the contract to be bid, with their complete qualification and experience data (*please see attached prescribed form required by the QC – BAC for Infrastructure and Consultancy*);
 - ☐ c. List of contractor’s major equipment units, which are owned, leased, and/or under purchase agreements, supported by proof of ownership or certification of availability of equipment from the equipment

lessor/vendor for the duration of the project, as the case may be (*please see attached prescribed form required by the QC – BAC for Infrastructure and Consultancy*); **and**

- ☐ (k) Original duly signed Omnibus Sworn Statement (OSS); **and** if applicable, Original Notarized Secretary's Certificate in case of a corporation, partnership, or cooperative; or Original Special Power of Attorney of all members of the joint venture giving full power and authority to its officer to sign the OSS and do acts to represent the Bidder.

Additional Technical Requirements:

- ☐ • Certificate of Site Inspection or Affidavit of Site Inspection as part of Omnibus Sworn Statement
- ☐ • Affidavit of Undertaking for Key Personnel and Equipment (*please see attached prescribed form required by the QC – BAC for Infrastructure and Consultancy*)
- ☐ • Equipment Utilization Schedule
- ☐ • Manpower Schedule
- ☐ • Construction Schedule and S-Curve
- ☐ • PERT-CMP
- ☐ • Construction Methods

Financial Documents

- ☐ (l) The prospective bidder's audited financial statements, showing, among others, the prospective bidder's total and current assets and liabilities, stamped "received" by the BIR or its duly accredited and authorized institutions, for the preceding calendar year which should not be earlier than two (2) years from the date of bid submission; **and**
- ☐ (m) The prospective bidder's computation of Net Financial Contracting Capacity (NFCC) (*please see attached prescribed form required by the QC – BAC for Infrastructure and Consultancy*).

Class "B" Documents

- ☐ (n) If applicable, duly signed joint venture agreement (JVA) in accordance with RA No. 4566 and its IRR in case the joint venture is already in existence; **or** duly notarized statements from all the potential joint venture partners stating that they will enter into and abide by the provisions of the JVA in the instance that the bid is successful.

II. FINANCIAL COMPONENT ENVELOPE

- ☐ (o) Original of duly signed and accomplished Financial Bid Form; **and**

Other documentary requirements under RA No. 9184

- ☐ (p) Original of duly signed Bid Prices in the Bill of Quantities; **and**
- ☐ (q) Duly accomplished Detailed Estimates Form, including a summary sheet indicating the unit prices of construction materials, labor rates, and equipment rentals used in coming up with the Bid; **and**
- ☐ (r) Cash Flow by Quarter.

Bid Form for the Procurement of Infrastructure Projects
[shall be submitted with the Bid]

BID FORM

Date : _____
Project Identification No. : _____

To: *[name and address of Procuring Entity]*

Having examined the Philippine Bidding Documents (PBDs) including the Supplemental or Bid Bulletin Numbers *[insert numbers]*, the receipt of which is hereby duly acknowledged, we, the undersigned, declare that:

- a. We have no reservation to the PBDs, including the Supplemental or Bid Bulletins, for the Procurement Project: *[insert name of contract]*;
- b. We offer to execute the Works for this Contract in accordance with the PBDs;
- c. The total price of our Bid in words and figures, excluding any discounts offered below is: *[insert information]*;
- d. The discounts offered and the methodology for their application are: *[insert information]*;
- e. The total bid price includes the cost of all taxes, such as, but not limited to: *[specify the applicable taxes, e.g. (i) value added tax (VAT), (ii) income tax, (iii) local taxes, and (iv) other fiscal levies and duties]*, which are itemized herein and reflected in the detailed estimates,
- f. Our Bid shall be valid within the a period stated in the PBDs, and it shall remain binding upon us at any time before the expiration of that period;
- g. If our Bid is accepted, we commit to obtain a Performance Security in the amount of *[insert percentage amount]* percent of the Contract Price for the due performance of the Contract, or a Performance Securing Declaration in lieu of the the allowable forms of Performance Security, subject to the terms and conditions of issued GPPB guidelines¹ for this purpose;
- h. We are not participating, as Bidders, in more than one Bid in this bidding process, other than alternative offers in accordance with the Bidding Documents;
- i. We understand that this Bid, together with your written acceptance thereof included in your notification of award, shall constitute a binding contract between us, until a formal Contract is prepared and executed; and
- j. We understand that you are not bound to accept the Lowest Calculated Bid or any other Bid that you may receive.

¹ currently based on GPPB Resolution No. 09-2020

- k. We likewise certify/confirm that the undersigned, is the duly authorized representative of the bidder, and granted full power and authority to do, execute and perform any and all acts necessary to participate, submit the bid, and to sign and execute the ensuing contract for the [Name of Project] of the [Name of the Procuring Entity].
- l. We acknowledge that failure to sign each and every page of this Bid Form, including the Bill of Quantities, shall be a ground for the rejection of our bid.

Name: _____

Legal Capacity: _____

Signature: _____

Duly authorized to sign the Bid for and behalf of: _____

Date: _____

Bid Securing Declaration Form

[shall be submitted with the Bid if bidder opts to provide this form of bid security]

REPUBLIC OF THE PHILIPPINES)

CITY OF _____) S.S.

BID SECURING DECLARATION **Project Identification No.: *[Insert number]***

To: *[Insert name and address of the Procuring Entity]*

I/We, the undersigned, declare that:

1. I/We understand that, according to your conditions, bids must be supported by a Bid Security, which may be in the form of a Bid Securing Declaration.
2. I/We accept that: (a) I/we will be automatically disqualified from bidding for any procurement contract with any procuring entity for a period of two (2) years upon receipt of your Blacklisting Order; and, (b) I/we will pay the applicable fine provided under Section 6 of the Guidelines on the Use of Bid Securing Declaration, within fifteen (15) days from receipt of the written demand by the procuring entity for the commission of acts resulting to the enforcement of the bid securing declaration under Sections 23.1(b), 34.2, 40.1 and 69.1, except 69.1(f), of the IRR of RA No. 9184; without prejudice to other legal action the government may undertake.
3. I/We understand that this Bid Securing Declaration shall cease to be valid on the following circumstances:
 - a. Upon expiration of the bid validity period, or any extension thereof pursuant to your request;
 - b. I am/we are declared ineligible or post-disqualified upon receipt of your notice to such effect, and (i) I/we failed to timely file a request for reconsideration or (ii) I/we filed a waiver to avail of said right; and
 - c. I am/we are declared the bidder with the Lowest Calculated Responsive Bid, and I/we have furnished the performance security and signed the Contract.

IN WITNESS WHEREOF, I/We have hereunto set my/our hand/s this ____ day of *[month]* *[year]* at *[place of execution]*.

[Insert NAME OF BIDDER OR ITS AUTHORIZED REPRESENTATIVE]

[Insert signatory's legal capacity]

Affiant

[Jurat]

[Format shall be based on the latest Rules on Notarial Practice]

Omnibus Sworn Statement (Revised)
[shall be submitted with the Bid]

REPUBLIC OF THE PHILIPPINES)
CITY/MUNICIPALITY OF _____) S.S.

AFFIDAVIT

I, [Name of Affiant], of legal age, [Civil Status], [Nationality], and residing at [Address of Affiant], after having been duly sworn in accordance with law, do hereby depose and state that:

1. *[Select one, delete the other:]*

[If a sole proprietorship:] I am the sole proprietor or authorized representative of [Name of Bidder] with office address at [address of Bidder];

[If a partnership, corporation, cooperative, or joint venture:] I am the duly authorized and designated representative of [Name of Bidder] with office address at [address of Bidder];

2. *[Select one, delete the other:]*

[If a sole proprietorship:] As the owner and sole proprietor, or authorized representative of [Name of Bidder], I have full power and authority to do, execute and perform any and all acts necessary to participate, submit the bid, and to sign and execute the ensuing contract for [Name of the Project] of the [Name of the Procuring Entity], as shown in the attached duly notarized Special Power of Attorney;

[If a partnership, corporation, cooperative, or joint venture:] I am granted full power and authority to do, execute and perform any and all acts necessary to participate, submit the bid, and to sign and execute the ensuing contract for [Name of the Project] of the [Name of the Procuring Entity], as shown in the attached [state title of attached document showing proof of authorization (e.g., duly notarized Secretary's Certificate, Board/Partnership Resolution, or Special Power of Attorney, whichever is applicable)];

3. [Name of Bidder] is not "blacklisted" or barred from bidding by the Government of the Philippines or any of its agencies, offices, corporations, or Local Government Units, foreign government/foreign or international financing institution whose blacklisting rules have been recognized by the Government Procurement Policy Board, **by itself or by relation, membership, association, affiliation, or controlling interest with another blacklisted person or entity as defined and provided for in the Uniform Guidelines on Blacklisting;**

4. Each of the documents submitted in satisfaction of the bidding requirements is an authentic copy of the original, complete, and all statements and information provided therein are true and correct;

5. [Name of Bidder] is authorizing the Head of the Procuring Entity or its duly authorized representative(s) to verify all the documents submitted;

6. *[Select one, delete the rest:]*

[If a sole proprietorship:] The owner or sole proprietor is not related to the Head of the Procuring Entity, members of the Bids and Awards Committee (BAC), the Technical Working Group, and the BAC Secretariat, the head of the Project Management Office or the end-user unit, and the project consultants by consanguinity or affinity up to the third civil degree;

[If a partnership or cooperative:] None of the officers and members of [Name of Bidder] is related to the Head of the Procuring Entity, members of the Bids and Awards Committee (BAC), the Technical Working Group, and the BAC Secretariat, the head of the Project

Management Office or the end-user unit, and the project consultants by consanguinity or affinity up to the third civil degree;

[If a corporation or joint venture:] None of the officers, directors, and controlling stockholders of *[Name of Bidder]* is related to the Head of the Procuring Entity, members of the Bids and Awards Committee (BAC), the Technical Working Group, and the BAC Secretariat, the head of the Project Management Office or the end-user unit, and the project consultants by consanguinity or affinity up to the third civil degree;

7. *[Name of Bidder]* complies with existing labor laws and standards; and
8. *[Name of Bidder]* is aware of and has undertaken the responsibilities as a Bidder in compliance with the Philippine Bidding Documents, which includes:
 - a. Carefully examining all of the Bidding Documents;
 - b. Acknowledging all conditions, local or otherwise, affecting the implementation of the Contract;
 - c. Making an estimate of the facilities available and needed for the contract to be bid, if any; and
 - d. Inquiring or securing Supplemental/Bid Bulletin(s) issued for the *[Name of the Project]*.
9. *[Name of Bidder]* did not give or pay directly or indirectly, any commission, amount, fee, or any form of consideration, pecuniary or otherwise, to any person or official, personnel or representative of the government in relation to any procurement project or activity.
10. **In case advance payment was made or given, failure to perform or deliver any of the obligations and undertakings in the contract shall be sufficient grounds to constitute criminal liability for Swindling (Estafa) or the commission of fraud with unfaithfulness or abuse of confidence through misappropriating or converting any payment received by a person or entity under an obligation involving the duty to deliver certain goods or services, to the prejudice of the public and the government of the Philippines pursuant to Article 315 of Act No. 3815 s. 1930, as amended, or the Revised Penal Code.**
11. We pledge that the project will be completed in accordance and congruency with the approved plans and programs.

IN WITNESS WHEREOF, I have hereunto set my hand this ___ day of _____ 20__ at _____, Philippines.

[Insert NAME OF BIDDER OR ITS AUTHORIZED REPRESENTATIVE]

[Insert signatory's legal capacity]
Affiant

[Jurat]

[Format shall be based on the latest Rules on Notarial Practice]

Contract Agreement Form for the Procurement of Infrastructure Projects (Revised)

[not required to be submitted with the Bid, but it shall be submitted within ten (10) days after receiving the Notice of Award]

CONTRACT AGREEMENT

THIS AGREEMENT, made this *[insert date]* day of *[insert month]*, *[insert year]* between *[name and address of PROCURING ENTITY]* (hereinafter called the "Entity") and *[name and address of Contractor]* (hereinafter called the "Contractor").

WHEREAS, the Entity is desirous that the Contractor execute *[name and identification number of contract]* (hereinafter called "the Works") and the Entity has accepted the Bid for *[contract price in words and figures in specified currency]* by the Contractor for the execution and completion of such Works and the remedying of any defects therein.

NOW THIS AGREEMENT WITNESSETH AS FOLLOWS:

1. In this Agreement, words and expressions shall have the same meanings as are respectively assigned to them in the Conditions of Contract hereinafter referred to.
2. The following documents as required by the 2016 revised Implementing Rules and Regulations of Republic Act No. 9184 shall be deemed to form and be read and construed as part of this Agreement, viz.:
 - a. Philippine Bidding Documents (PBDs);
 - i. Drawings/Plans;
 - ii. Specifications;
 - iii. Bill of Quantities;
 - iv. General and Special Conditions of Contract;
 - v. Supplemental or Bid Bulletins, if any;
 - b. Winning bidder's bid, including the Eligibility requirements, Technical and Financial Proposals, and all other documents or statements submitted;

Bid form, including all the documents/statements contained in the Bidder's bidding envelopes, as annexes, and all other documents submitted (e.g., Bidder's response to request for clarifications on the bid), including corrections to the bid, if any, resulting from the Procuring Entity's bid evaluation;
 - c. Performance Security;
 - d. Notice of Award of Contract and the Bidder's conforme thereto; and
 - e. Other contract documents that may be required by existing laws and/or the Procuring Entity concerned in the PBDs. **Winning bidder agrees that additional contract documents or information prescribed by the GPPB that are subsequently required for submission after the contract execution, such as the Notice to Proceed, Variation Orders, and Warranty Security, shall likewise form part of the Contract.**
3. In consideration for the sum of *[total contract price in words and figures]* or such other sums as may be ascertained, *[Named of the bidder]* agrees to *[state the object of the contract]* in accordance with his/her/its Bid.

4. The *[Name of the procuring entity]* agrees to pay the above-mentioned sum in accordance with the terms of the Bidding.

IN WITNESS whereof the parties thereto have caused this Agreement to be executed the day and year first before written.

[Insert Name and Signature] [Insert Name and Signature]

[Insert Signatory's Legal Capacity] [Insert Signatory's Legal Capacity]

for: for:

[Insert Procuring Entity] [Insert Name of Supplier]

Acknowledgment

[Format shall be based on the latest Rules on Notarial Practice]

LIST OF ALL ON-GOING GOVERNMENT AND PRIVATE CONTRACTS

NAME OF CONTRACTOR: _____

PROJECT TITLE (Name of the Contract) & EXACT PROJECT LOCATION	DATE OF CONTRACT	CONTRACT DURATION	PROJECT OWNER & POSTAL ADDRESS	NATURE OF WORK	CONTRACTOR'S ROLE (SOLE CONTRACTOR, SUBCONTRACTOR, PARTNER IN A JV) and PERCENTAGE OF PARTICIPATION	TOTAL CONTRACT VALUE AT AWARD	DATE OF COMPLETION or ESTIMATED COMPLETION TIME	TOTAL CONTRACT VALUE AT COMPLETION IF APPLICABLE	PERCENTAGE		VALUE OF OUTSTANDING WORKS (IN PHP)
									ACTUAL ACCOMPLISHMENT	PLANNED ACCOMPLISHMENT	
									TOTAL AMOUNT (Php) OF OUTSTANDING WORKS		

PHOTOCOPY ADDITIONAL FORMS, IF NECESSARY

Page _____ of _____

SINGLE LARGEST COMPLETED CONTRACT SIMILAR TO THE CONTRACT TO BE BID

NAME OF CONTRACTOR: _____

PROJECT TITLE: _____

PROJECT TITLE (Name of the Contract) & EXACT PROJECT LOCATION	DATE OF CONTRACT	CONTRACT DURATION	PROJECT OWNER & POSTAL ADDRESS	NATURE OF WORK	CONTRACTOR'S ROLE (SOLE CONTRACTOR, SUBCONTRACTOR, PARTNER IN A JV) and PERCENTAGE OF PARTICIPATION	TOTAL CONTRACT VALUE AT AWARD	DATE OF COMPLETION or ESTIMATED COMPLETION TIME	TOTAL CONTRACT VALUE AT COMPLETION IF APPLICABLE

PHOTOCOPY ADDITIONAL FORMS, IF NECESSARY

Page _____ of _____

LIST OF MAJOR EQUIPMENT TO BE USED FOR THE PROJECT

NAME OF CONTRACTOR: _____

PROJECT TITLE: _____

TYPE	DESCRIPTION / CAPACITY	SERIAL NO.	YEAR ACQUIRED	PRESENT LOCATION (SPECIFIC ADDRESS)	STATUS OF AVAILABILITY (OWNED/LEASED)

A. LIST OF KEY CONSTRUCTION PERSONNEL TO BE ASSIGNED TO THE PROJECT

NAME OF CONTRACTOR: _____

PROJECT TITLE: _____

NAME	POSITION	AGE	EDUCATIONAL ATTAINMENT	TYPE OF CONSTRUCTION EXPERIENCE	NO.OF YEARS WITH THE CONTRACTOR	PROFESSION	PRC NO.

COMPUTATION OF NET FINANCIAL CONTRACTING CAPACITY (NFCC)

NAME OF BIDDER: _____

CURRENT ASSETS*		PHP	_____
(LESS) CURRENT LIABILITIES*	(LESS)	PHP	_____
NETWORTH		PHP	_____
NETWORTH x 15	x 15	PHP	_____
(LESS) VALUE OF ALL OUTSTANDING ON-GOING CONTRACTS**	(LESS)	PHP	_____
(LESS) VALUE OF ALL AWARDED BUT NOT YET STARTED CONTRACTS AS OF DATE**	(LESS)	PHP	_____
NET FINANCIAL CONTRACTING CAPACITY		PHP	_____

NOTES: * CURRENT ASSETS AND LIABILITIES BASED ON AUDITED FINANCIAL STATEMENT FOR THE PRECEDING CALENDAR YEAR SUBMITTED TO B.I.R.

 ** BASED ON LIST OF ON-GOING AND AWRDED BUT NOT VEY STARTED CONTRACTS SUBMITTED

REPUBLIC OF THE PHILIPPINES)

_____) S.S.

AFFIDAVIT OF UNDERTAKING

I, _____ of legal age, Filipino, _____ **[OFFICER OR REPRESENTATIVE]**

with office address at _____ after having been duly sworn to in accordance with law, hereby voluntary depose and state:

That I am duly authorized representative of the **[Name of Bidder]** to execute this undertaking as evidenced by Secretary's Certificate and Board Resolution.

That **[Name of Bidder]** bidding for the (Name of Project)

That relative to the aforementioned Project, the **[Name of Bidder]** hereby undertake that the equipment to be use and the key personnel to be assign shall exclusively be used and will only perform to the said project until its completion.

That I am executing this affidavit to attest to the truth of the foregoing and in compliance with the submission of the technical requirements for the public bidding of the said project.

IN WITNESS HEREOF, I have hereunto signed my name below this _____ day of _____ at _____.

AFFIANT FURTHER SAYETH NAUGHT.

Affiant

SUBSCRIBED AND SWORN TO BEFORE ME this _____ day of _____
in _____

affiant exhibiting to me his/her _____ issued at _____
on _____.

Doc. No. ;
Page No. ;
Book No. ;
Series of 2020

Notary Public

